LTBBOI WWTF UPGRADES **ADDENDUM 1**

LTBBOI

Emmet County, Michigan

Wastewater Treatment Facility Upgrades

PROJ #240217 ADDENDUM #1 DATE:11/12/2024

NOTICE: This Addendum No.1, issued in accordance with the Contract Documents, is incorporated into the Contract Documents and supersedes and updates all conflicting information and is hereby amended in certain particulars as follows:

Date: November 12, 2024

CHANGES TO THE PLANS:

1. SEE ATTACHED DRAWING SET

- a. Added Sheet A1- FLOOR PLAN
- b. Added Sheet S1 STRUCTURAL DETAILS

ADDENDUM ACKNOWLEDGMENT:

This Addendum No. 1 shall be attached to and shall become a part of the Contract Documents. Acknowledge receipt of this Addendum in the space provided on the Bid Form. Failure to do so may result in the rejection of the Bid.

END SECTION

DISTRIBUTION: (via email)


All Plan Holders
Posted to website

WASTEWATER TREATMENT FACILITY UPGRADES

FOR

LITTLE TRAVERSE BAY BANDS OF ODAWA INDIANS

EMMET COUNTY, MICHIGAN

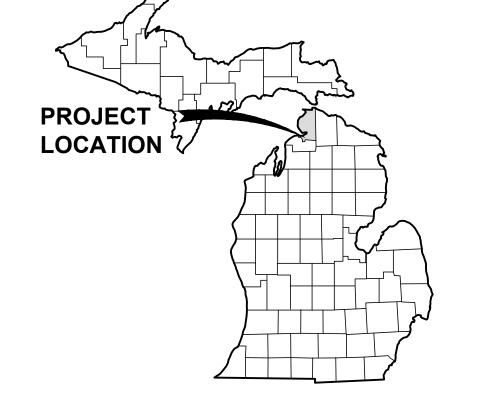

VICINITY MAP

OWNER

LITTLE TRAVERSE BAY BANDS OF ODAWA INDIANS

7500 Odawa Cir. Harbor Springs, Michigan, 49740 231.242.1400

ENGINEER

GOSLING CZUBAK ENGINEERING SCIENCES. INC.

UTILITY CONTACTS

NAME OF OWNER	

BANDS OF ODAWA INDIANS 7500 ODAWA CIRCLE HARBOR SPRINGS, MI 49740 231.242.1420

DTE ENERGY

CONTACT: BARBARA SAUNDERS

LANSING, MI 48906 517.374.2002 CONTACT: KURT GOLDING

CHARTER COMMUNICATIONS 1392 TRADE CENTRE DR

TRAVERSE CITY, MI 49696 810.247.3899 CONTACT: PATRICK DELISI

54 N MILL ST, 4TH FLOOR PONTIAC, MI 48342 517.515.4794 CONTACT: HEATHER VALLEE-KNOBLAUCH

203 W 9TH ST LORAIN, OH 44052 440.244.8415

CONTACT: BOBBY WALTERS

CHERRYLAND ELECTRIC COOP.

TYPE OF UTILITY

SEWER SYSTEM LITTLE TRAVERSE BAY

DAUGHERTY A. JOHNSON

313.235.5111

CONSUMER'S ENERGY 530 W WILLOW ST

CABLE TV


ELECTRIC

TELEPHONE

CENTURYLINK INTERNET

ELECTRIC

5930 US 31 S GRAWN, MI 49637 231.486.9239 CONTACT: JASON RICE

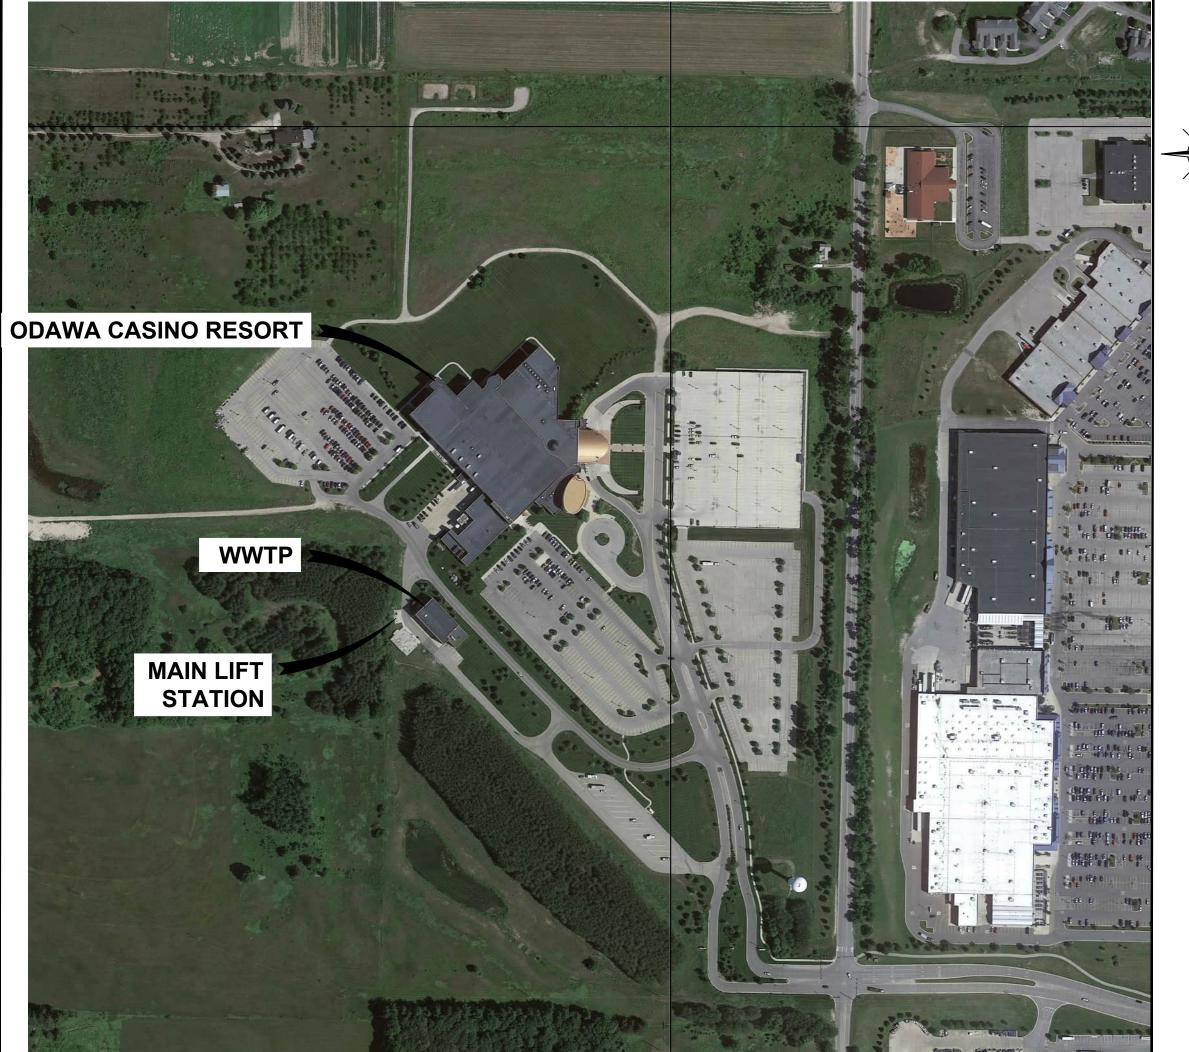



	SHEET LIST
SHEET NUMBER	SHEET TITLE
COVER	COVER
C1	LIFT STATION PUMP REPLACEMENT PLAN
C2	SCREEN RELACEMENT PLAN
C3	TEMPORARY SCREENING PLAN
SE1	ELECTRICAL SITE PLAN
E0	ELECTRICAL LEGEND AND DETAILS
E1	ELECTRICAL FLOOR PLANS
E2	ELECTRICAL RISER DIAGRAM & PANEL SCHEDULE
A1	FLOOR PLAN
S1	STRUCTURAL DETAILS
	A A A

Know what's below. Call before you dig.

COVER


Issue Date

11/11/2024

Project No.

240217

Sheet

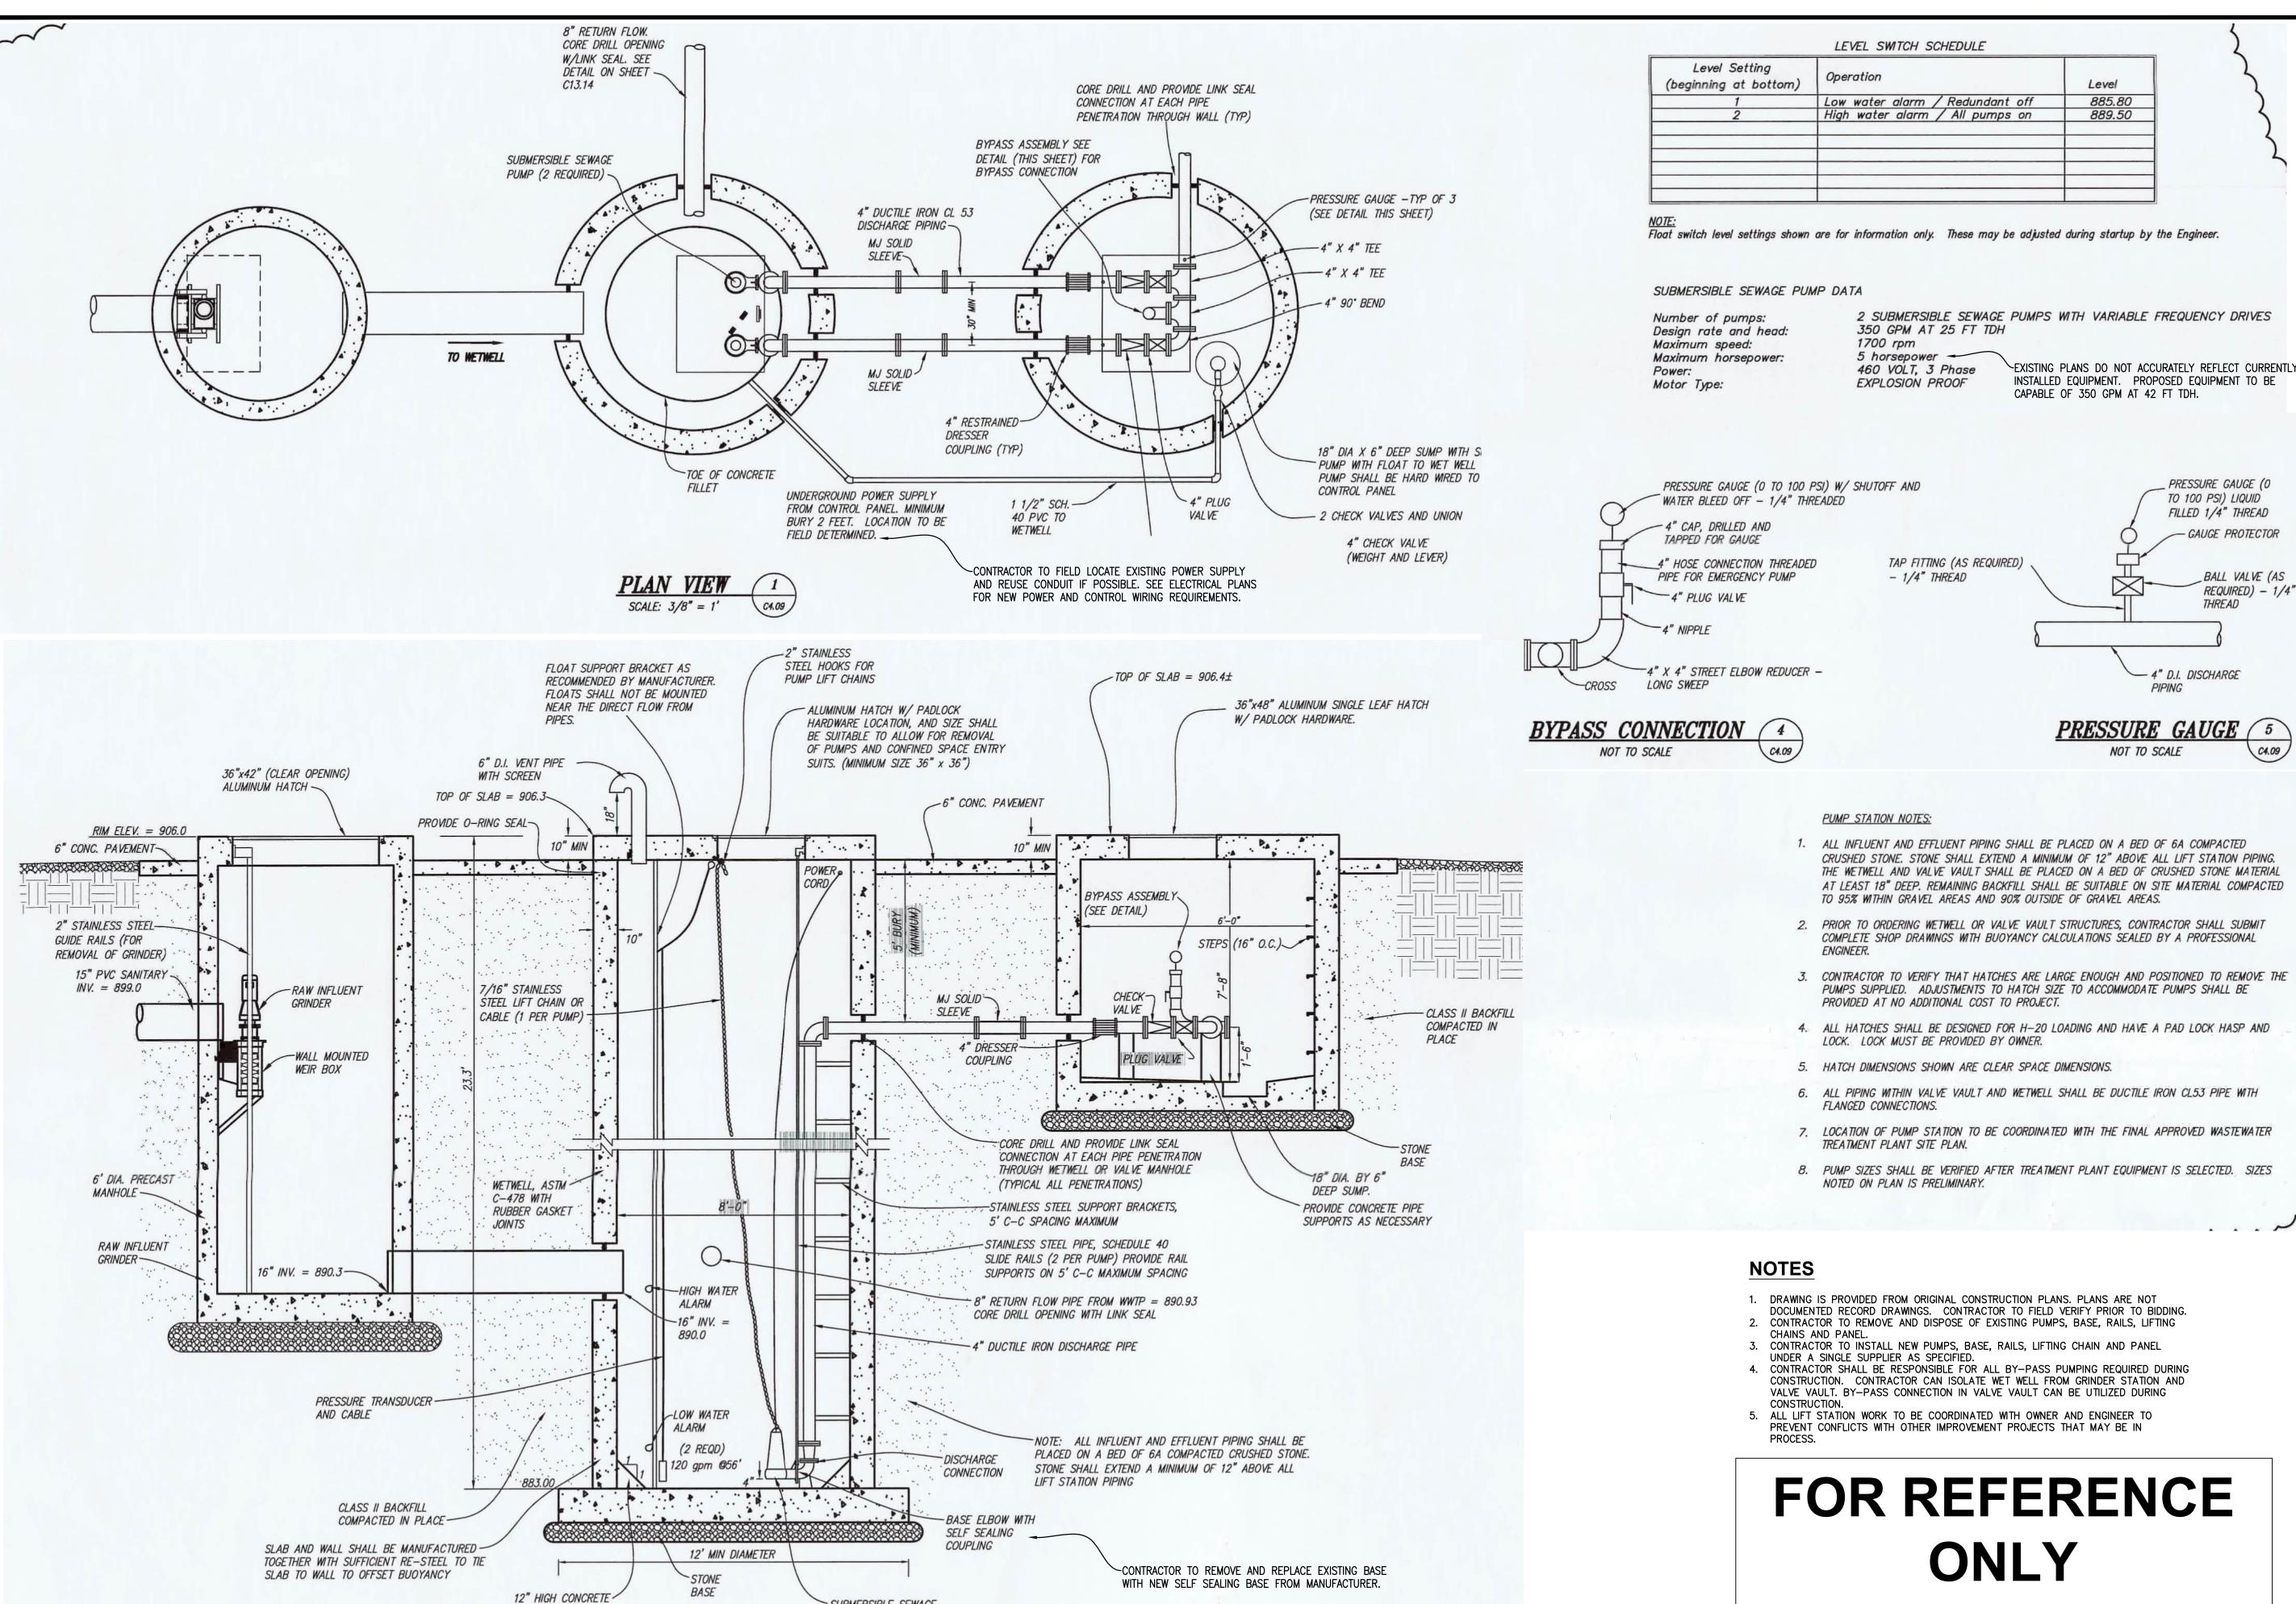

SUBMERSIBLE SEWAGE

PUMP (2 ALTERNATING)

FILLETS OF NON-

SHRINKING GROUT

iosling Lzubal

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www.goslingczubak.com

CIVIL ENGINEERING SURVEYING **ENVIRONMENTAL SERVICES** GEOTECHNICAL **CONSTRUCTION SERVICES**

LANDSCAPE ARCHITECTURE

C4.09

- 4" D.I. DISCHARGE

- 1. ALL INFLUENT AND EFFLUENT PIPING SHALL BE PLACED ON A BED OF 6A COMPACTED CRUSHED STONE. STONE SHALL EXTEND A MINIMUM OF 12" ABOVE ALL LIFT STATION PIPING. THE WETWELL AND VALVE VAULT SHALL BE PLACED ON A BED OF CRUSHED STONE MATERIAL AT LEAST 18" DEEP. REMAINING BACKFILL SHALL BE SUITABLE ON SITE MATERIAL COMPACTED
- 2. PRIOR TO ORDERING WETWELL OR VALVE VAULT STRUCTURES, CONTRACTOR SHALL SUBMIT COMPLETE SHOP DRAWINGS WITH BUOYANCY CALCULATIONS SEALED BY A PROFESSIONAL
- 3. CONTRACTOR TO VERIFY THAT HATCHES ARE LARGE ENOUGH AND POSITIONED TO REMOVE THE PUMPS SUPPLIED. ADJUSTMENTS TO HATCH SIZE TO ACCOMMODATE PUMPS SHALL BE
- 4. ALL HATCHES SHALL BE DESIGNED FOR H-20 LOADING AND HAVE A PAD LOCK HASP AND
- 6. ALL PIPING WITHIN VALVE VAULT AND WETWELL SHALL BE DUCTILE IRON CL53 PIPE WITH
- 8. PUMP SIZES SHALL BE VERIFIED AFTER TREATMENT PLANT EQUIPMENT IS SELECTED. SIZES


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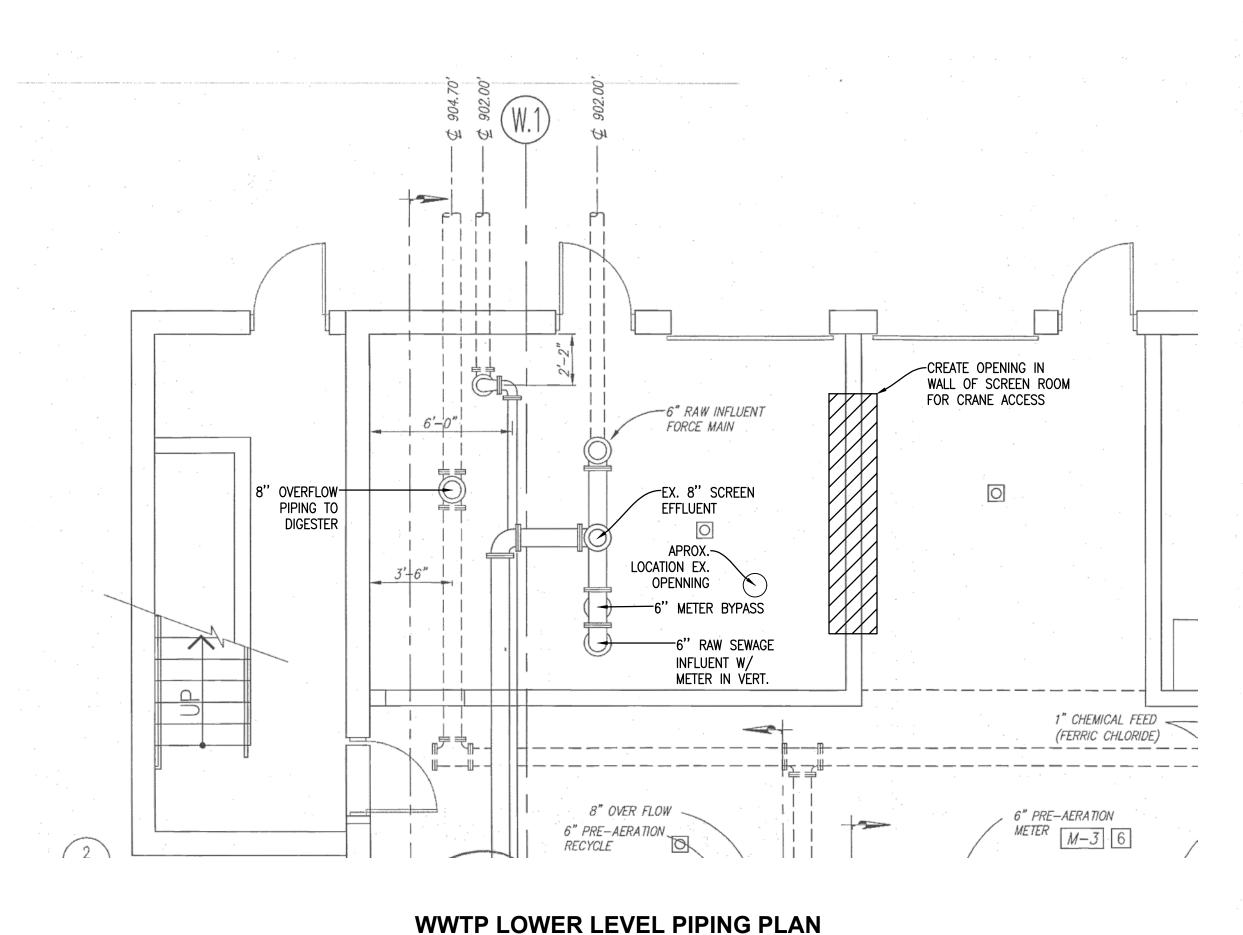
PLAN GRADI

Drawn By: Checked By: Original sheet size is 22x34 SECTION 12 T 34 N, R 06 W


RESORT TOWNSHIP EMMET COUNTY, MI

Project Number: 240217




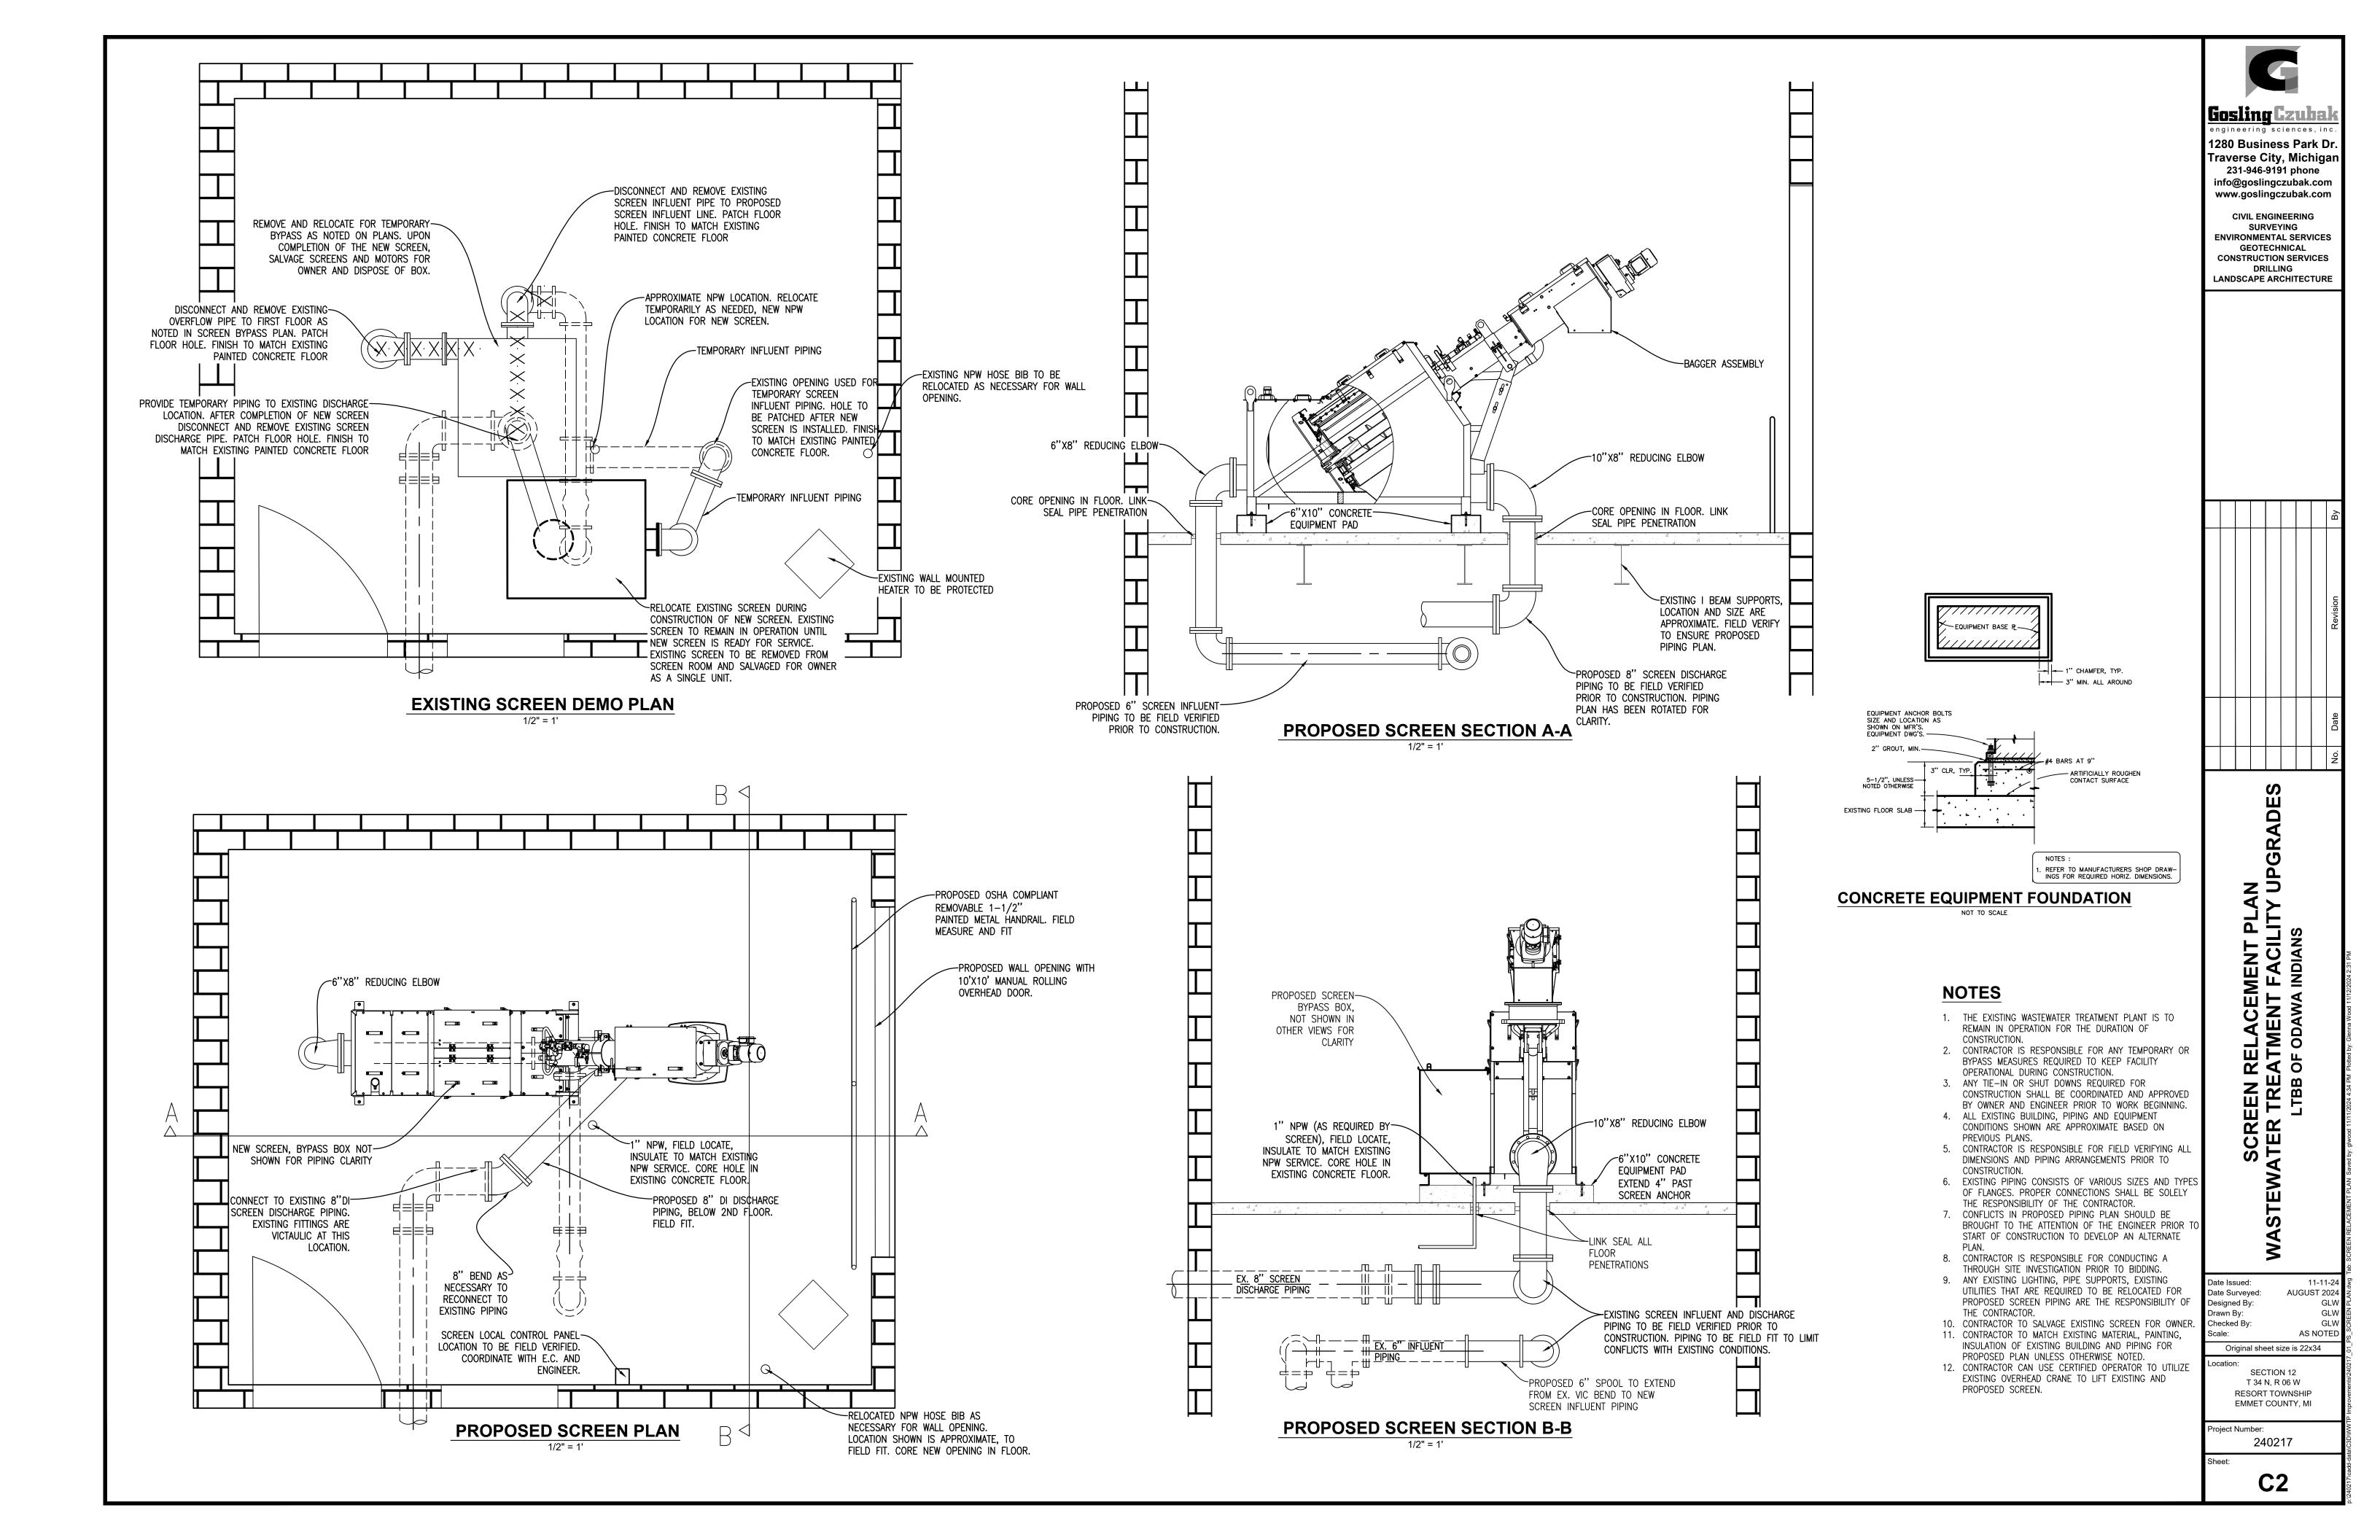



SCALE: NOT TO SCALE

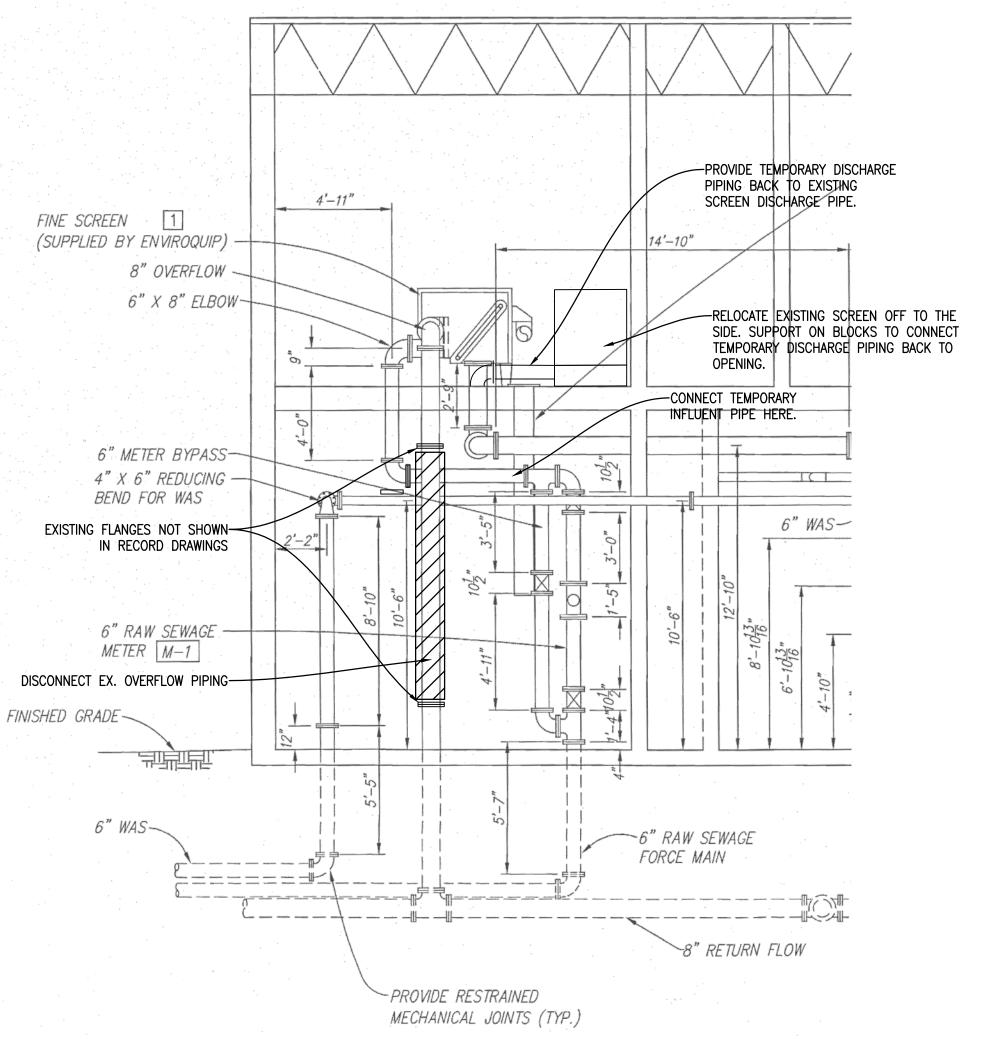

WWTP LOWER LEVEL PIPING SECTION SCALE: NOT TO SCALE

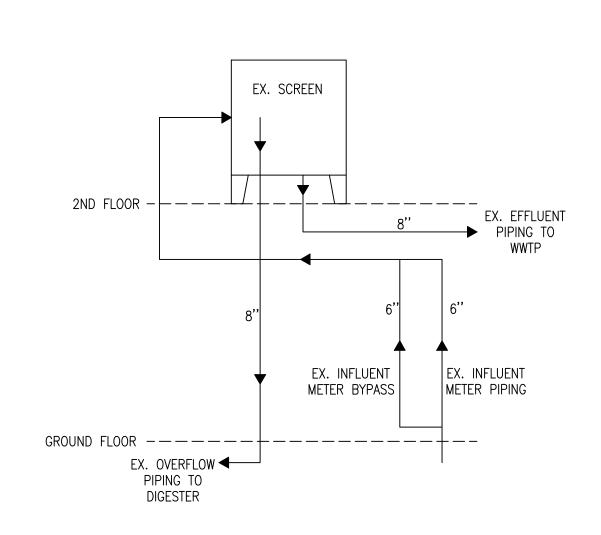

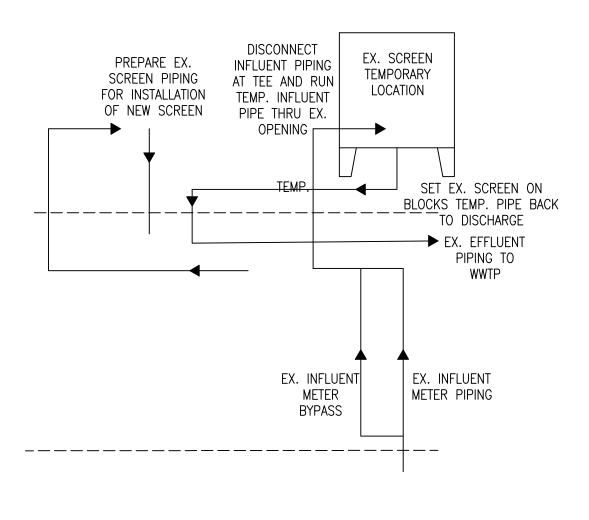

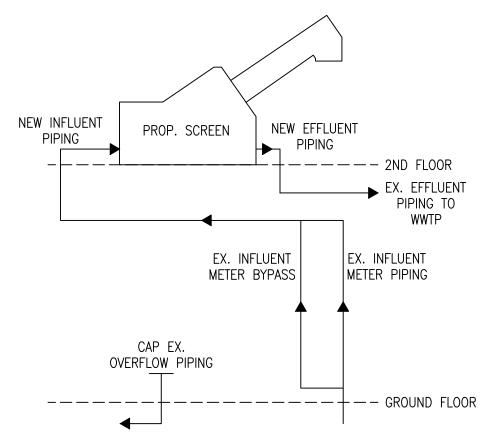

EXISTING PROCESS SCHEMATIC

TEMPORARY PROCESS SCHEMATIC

PROPOSED PROCESS SCHEMATIC

SUGGESTED SEQUENCE OF OPERATION

- 1. CONTRACTOR TO FIELD MEASURE AND VERIFY ALL PIPE SIZE AND BUILDING DIMENSIONS PRIOR TO CONSTRUCTION.
- 2. DISCONNECT WATER SERVICE LINE ON EXISTING EAST WALL OF SECOND FLOOR
- SCREEN ROOM. 3. CREATE OPENING IN EXISTING EAST CMU WALL OF SECOND FLOOR SCREEN ROOM
- LARGE ENOUGH TO REMOVE EXISTING SCREEN AND INSERT PROPOSED SCREEN. 4. PREPARE PIPING FOR TEMPORARY RELOCATION OF EXISTING SCREEN TO THE SIDE OF THE EXISTING SCREENING ROOM:
- 4.1. DISCONNECT EXISTING OVERFLOW PIPING. BLIND FLANGE OVERFLOW ON SCREEN FOR TEMPORARY USE. OVERFLOW PIPE TO BE REMOVED DOWN TO FLANGE AT FIRST FLOOR.
- 4.2. INSTALL TEMPORARY PIPING IN EXISTING UNUSED OPENING IN SCREENING ROOM FLOOR BACK TO EXISTING TEE DOWNSTREAM OF THE INFLUENT METER AND BYPASS LINE.
- 5. PREPARE TO RELOCATE EXISTING SCREEN TO TEMPORARY LOCATION IN THE SCREEN ROOM.
- 5.1. PROVIDE PUMPING AND HAULING SERVICES AT INFLUENT LIFT STATION TO DIVERT ALL FLOW FROM THE WWTP FOR THE DURATION THAT THE SCREEN IS DISCONNECTED.

RECONNECT EXISTING SCREEN TO TEMPORARY INFLUENT PIPING FROM


- 5.2. DISCONNECT POWER, NON-POTABLE WATER CONNECTIONS, INFLUENT AND EFFLUENT PIPING FROM EXISTING SCREEN.
- MOVE EXISTING SCREEN TO TEMPORARY LOCATION.
- 5.4. CONNECT TEMPORARY INFLUENT PIPING TO THE INFLUENT LINE JUST DOWNSTREAM OF TEE.
- INFLUENT PIPE AND EFFLUENT PIPE AS SHOWN IN PROCESS SCHEMATICS.
- RECONNECT NON-POTABLE WATER AND POWER TO EXISTING SCREEN AT TEMPORARY LOCATION.
- 6. WHILE THE TEMPORARY SCREENING SYSTEM IS RUNNING, PREPARE PIPING FOR INSTALLATION OF NEW SCREEN.
- 6.1. INSTALL NEW PIPING AND FITTINGS IN SECOND FLOOR SCREEN ROOM TO ACCOMMODATE NEW SCREEN.
- 6.2. LIFT NEW SCREEN TO SECOND FLOOR SCREEN ROOM AND INSTALL PER
- MANUFACTURER STANDARDS.
- 6.3. RECONNECT FLOW TO WWTP THROUGH NEW SCREEN. 7. DISCONNECT TEMPORARY SCREEN AND REMOVE TEMPORARY POWER.
- 8. CAP EXISTING OVERFLOW PIPING AT FLOOR AND REMOVE EXISTING OVERFLOW
- PIPING THROUGH CEILING.
- 9. INSTALL REMOVABLE SAFETY RAILING ALONG NEW OPENING OF EAST WALL.

NOTES

- 1. DRAWING IS PROVIDED FROM ORIGINAL CONSTRUCTION PLANS. PLANS ARE NOT DOCUMENTED RECORD DRAWINGS. CONTRACTOR TO FIELD VERIFY PRIOR TO
- 2. SUGGESTED SEQUENCE OF OPERATION IS ONLY A SUGGESTION, CONTRACTOR IS RESPONSIBLE FOR ALL TEMPORARY OR BYPASS MEASURES REQUIRED FOR THE DURATION OF CONSTRUCTION SO THAT THE OWNER CAN MAINTAIN OPERATION OF THE TREATMENT FACILITY.
- 3. ALL TEMPORARY SCREEN SET UP AND REMOVAL ARE TO BE BID AS INCIDENTAL TO THE NEW SCREEN WORK.

Gosling Czubal

1280 Business Park Dr Traverse City, Michigar 231-946-9191 phone info@goslingczubak.com www.goslingczubak.com CIVIL ENGINEERING SURVEYING **ENVIRONMENTAL SERVICES** GEOTECHNICAL CONSTRUCTION SERVICES LANDSCAPE ARCHITECTURE

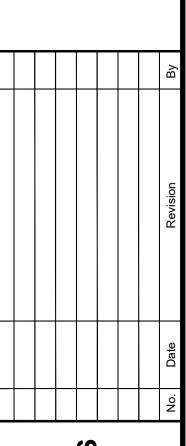

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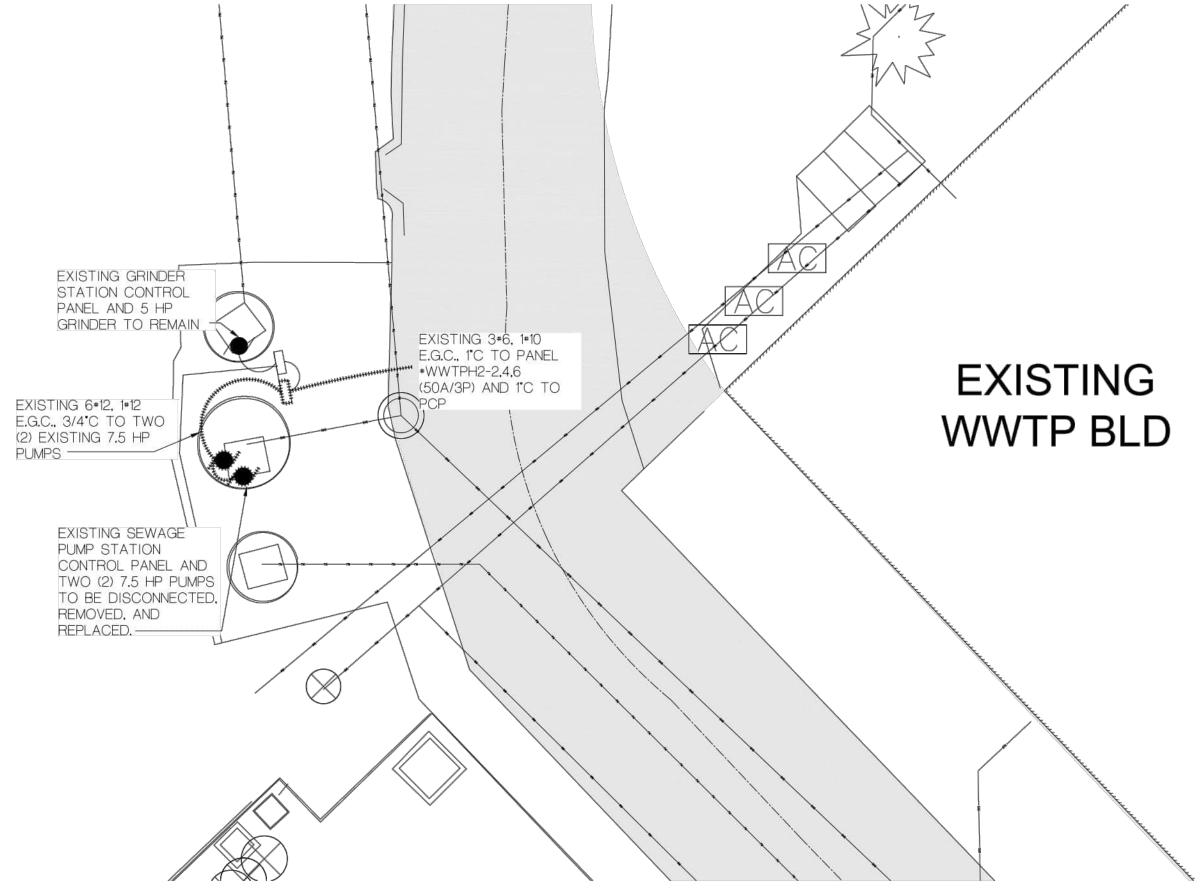
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RESORT TOWNSHIP EMMET COUNTY, MI Project Number:

240217

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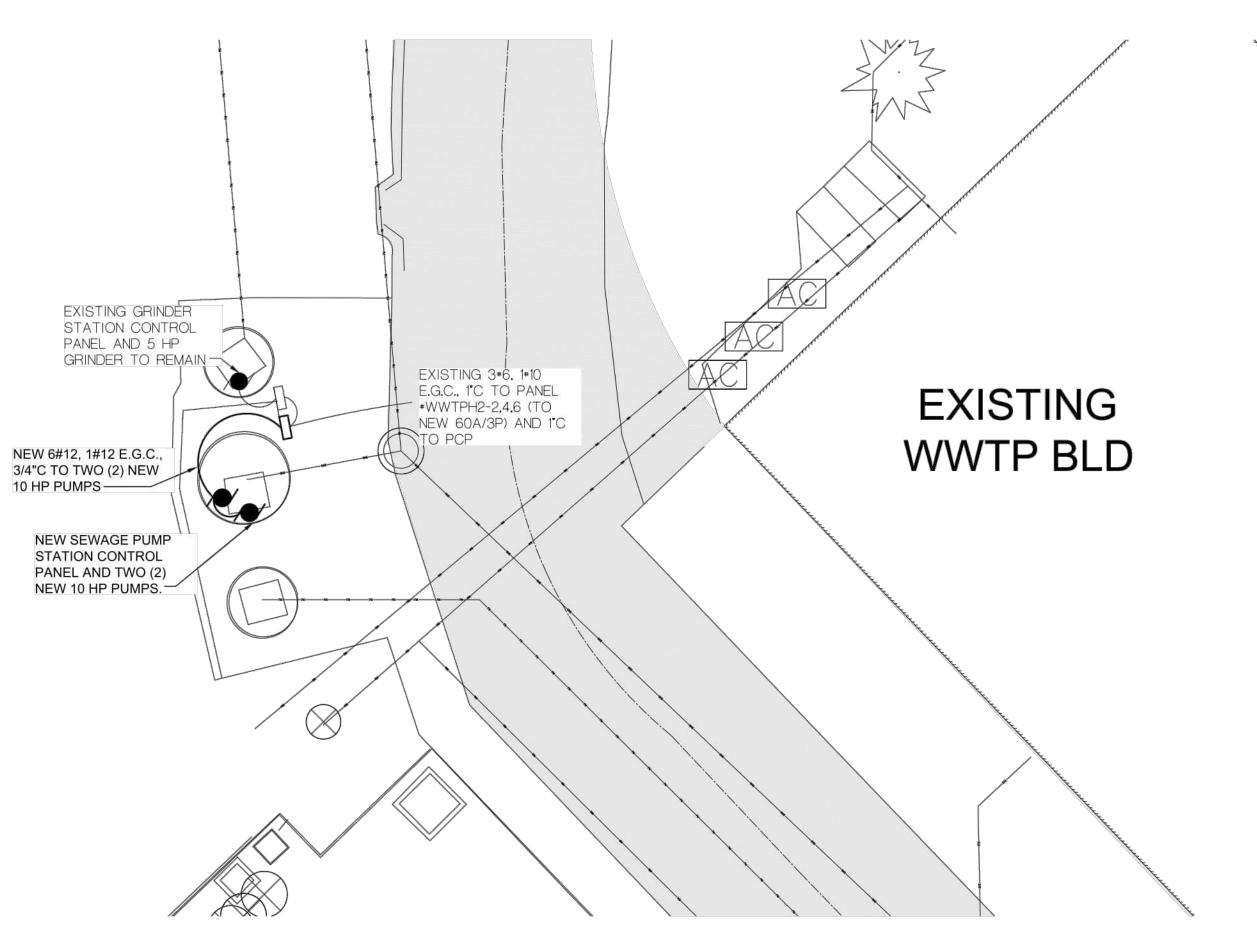


ELECTRICAL DEMOLITION SITE PLAN

ELECTRICAL SITE PLAN

SCALE: 1" = 10'

SCALE: 1" = 10'




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GRADES

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SECTION 12 T 34 N, R 06 W RESORT TOWNSHIP

EMMET COUNTY, MI

240217


SE1

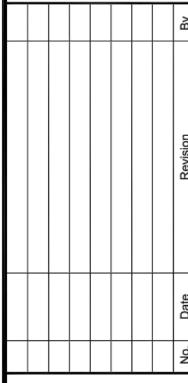ELECTRICAL CVMPOL LECEND

	ELECTRICAL SYMBOL LEGEND										
SYMBOL	DESCRIPTION	NOTES									
S	SINGLE POLE SWITCH	MOUNT @ 44" A.F.F. TO BOTTOM OF BOX, UNLESS OTHERWISE NOTED									
S₃	THREE-WAY SWITCH	MOUNT @ 44" A.F.F. TO BOTTOM OF BOX, UNLESS OTHERWISE NOTED									
S ₄	FOUR-WAY SWITCH	MOUNT @ 44" A.F.F. TO BOTTOM OF BOX, UNLESS OTHERWISE NOTED									
\mathbf{z}_{x}	WALL MOUNTED FIXTURE, TYPE X	SEE LIGHTING FIXTURE SCHEDULE FOR TYPES									
\bigcirc^{x}	ROUND FIXTURE, TYPE X	SEE LIGHTING FIXTURE SCHEDULE FOR TYPES									
X	2'x4' FIXTURE, TYPE X	SEE LIGHTING FIXTURE SCHEDULE FOR TYPES									
X	1'x4' FIXTURE, TYPE X	SEE LIGHTING FIXTURE SCHEDULE FOR TYPES									
\triangle^{X}	WALL MOUNTED FIXTURE, TYPE X	SEE LIGHTING FIXTURE SCHEDULE FOR TYPES									
⊗ <i>x</i>	EXIT SIGN, TYPE X	SEE LIGHTING FIXTURE SCHEDULE FOR TYPES									
(PC)	PHOTOCELL	INTERMATIC #K4321									
\rightarrow	DUPLEX OUTLET - 20 AMP	MOUNT @ 16" A.F.F. TO BOTTOM OF BOX, UNLESS OTHERWISE NOTED									
$egin{array}{c} 0 \\ 0 \end{array}$	DUPLEX OUTLET - WEATHER PROOF "IN-USE" COVER	MOUNT @ 24" A.F.F. TO BOTTOM OF BOX, UNLESS OTHERWISE NOTED									
0	DUPLEX OUTLET - GROUND FAULT - 20 AMP	MOUNT @ 16" A.F.F. TO BOTTOM OF BOX, UNLESS OTHERWISE NOTED									
•	DUPLEX OUTLET - DEDICATED CIRCUIT	MOUNT @ 16" A.F.F. TO BOTTOM OF BOX, UNLESS OTHERWISE NOTED									
₩	208V, 4 WIRE OUTLET, AS SPECIFIED	MOUNT @ 16" A.F.F. TO BOTTOM OF BOX, UNLESS OTHERWISE NOTED									
\bigcirc	SINGLE-PHASE SPECIAL PURPOSE OUTLET, AS NOTED	REFER TO SHOP DRAWINGS FOR CONNECTION REQUIREMENTS									
	THREE-PHASE SPECIAL PURPOSE OUTLET, AS NOTED	REFER TO SHOP DRAWINGS FOR CONNECTION REQUIREMENTS									
J	JUNCTION BOX WITH BLANK COVER, AS SPECIFIED										
<i>\O</i> '	SINGLE-PHASE MOTOR, AS SPECIFIED										
/	THREE-PHASE MOTOR, AS SPECIFIED										
마	SINGLE-PHASE FUSED OR NON-FUSED DISCONNECT										
ď	SINGLE-PHASE MANUAL STARTER OR COMB. DISC./STARTER										
	THREE-PHASE FUSED OR NON-FUSED DISCONNECT										
	THREE-PHASE MANUAL STARTER OR COMB. DISC./STARTER										
S _M	MOTOR TOGGLE SWITCH WITH THERMAL OVERLOAD AND LOCKOUT	SQUARE D #CLASS 2510 FGJ5P (SINGLE POLE)									
	DISTRIBUTION POWER PANELS	REFER TO SPECIFICATIONS AND ONE-LINE DIAGRAM.									
	LIGHTING/BRANCH CIRCUIT PANELS	REFER TO SPECIFICATIONS AND ONE-LINE DIAGRAM.									
∇	DATA OUTLET	E.C. TO PROVIDE AND INSTALL 4" SQ. x 2-1/8" DEEP BOX WITH 2" DEEP PLASTER RING AND 1" CONDUIT STUBBED ABOVE CEILING.									
BPS	FIRE ALARM BOOSTER POWER SUPPLY - SIEMENS PAD-4 SERIES	ALL FIRE ALARM MATERIALS AND DEVICES SHALL BE COMPATIBLE WITH THE EXISTING SIEMENS SYSTEM DEVICES AND EQUIPMENT. CONTACT JEFFREY VANSKIVER - (616.293.3936 OR jeffrey.vanskiver@siemens.com) FOR BIDDING AND INSTALLATION INFORMATION.									
¬D	FIRE ALARM VISIBLE - SIEMENS ZR SERIES	MOUNT @ MIN. 80", MAX. 96" A.F.F.									
□□□	FIRE ALARM AUDIBLE/VISIBLE - SIEMENS ZH SERIES	MOUNT @ MIN. 80", MAX. 96" A.F.F.									
¬ Oxp	FIRE ALARM VISIBLE - EXPLOSION PROOF - CROUSE-HINDS XB11 SERIES	MOUNT @ MIN. 80", MAX. 96" A.F.F.									
¬¬ ДXP/S	FIRE ALARM SPEAKER - EXPLOSION PROOF - CROUSE-HINDS DB3B SERIES	MOUNT @ MIN. 80", MAX. 96" A.F.F.									
(S _D)	FIRE ALARM SMOKE DETECTOR										
	SECURITY CAMERA	E.C. TO PROVIDE AND INSTALL 4" SQ. x 2-1/8" DEEP WEATHERPROOF BOX WITH 2" DEEP PLASTER RING AND 1" CONDUIT TO SECURITY PANEL.									

			ABBREV	IATION	S		
1-21	PANEL 1, CIRCUIT 21	ЕМТ	ELECTRICAL METALLIC TUBING	мс	MECHANICAL CONTRACTOR	RGS	RIGID GALVANIZED STEEL
Α	AMPERES	ERV	ENERGY RECOVERY VENTILATOR	МСВ	MAIN CIRCUIT BREAKER	TR	TAMPER RESISTANT
AC	ABOVE COUNTER	E-R	EXISTING TO BE RELOCATED	MDP	MAIN DISTRIBUTION PANEL	TVSS	TRANSIENT VOLTAGE SURGE SUPPRESSION
AFF	ABOVE FINISH FLOOR	ETR	EXISTING TO REMAIN	MLO	MAIN LUG ONLY	UGRD	UNDERGROUND
AFG	ABOVE FINISH GRADE	EWC	ELECTRIC WATER COOLER	NL	NIGHT LIGHT	UON	UNLESS OTHERWISE NOTED
ВС	BELOW COUNTER	EWH	ELECTRIC WATER HEATER	NTS	NOT TO SCALE	V	VOLT
С	CONDUIT	EXP	EXPLOSION PROOF	OFCI	OWNER FURNISHED, CONTRACTOR INSTALLED	VFD	VARIABLE FREQUENCY DRIVE
C/B, CB	CIRCUIT BREAKER	G	GROUND	Р	PUMP	VIF	VERIFY IN FIELD
DWG	DRAWING	GEC	GROUNDING ELECTRODE CONDUCTOR	PNL	PANEL	W	WIRE
E	EXISTING TO REMAIN	GFI	GROUND FAULT CIRCUIT INTERRUPTER	PS	PRIMARY SWITCH	WG	WIREGUARD
EC	ELECTRICAL CONTRACTOR	KCMIL	THOUSAND CIRCULAR MILS	PT	PRIMARY TRANSFORMER	WP	WEATHERPROOF
EF	EXHAUST FAN	KVA	KILOVOLT-AMPERES	PVC	POLYVINYL CHLORIDE	XFMR	TRANSFORMER
EGC	EQUIPMENT GROUNDING CONDUCTOR	KW	KILOWATTS	Q	QUADRIPLEX (DOUBLE DUPLEX) RECEPTACLE		

ELECTRICAL IDENTIFICATION

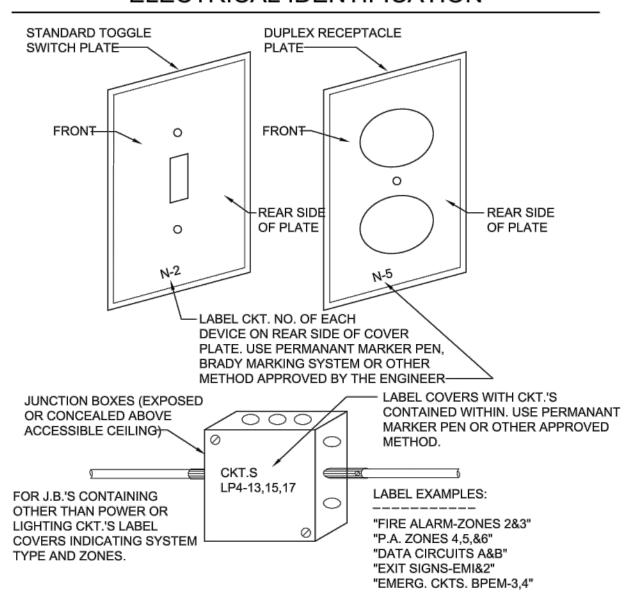

WIRE SIZE REQUIREMENTS

NOTE:
BASED ON A MAXIMUM OF 3.6-VOLT DROP (3%) ON 120V CIRCUITS. WIRES FOR RUNS OVER 100'-0" SHALL BE DETERMINED ON THIS A MAXIMUM OF A 3% DROP ALLOWED.

BRANCH CIRCUIT AMPS		LENGTH OF RUN - FROM PANEL TO FIRST CONNECTION - FEET									
AMPS	50'	60'	70'	80'	90'	100'	110'	120'	130'		
15	#12	#12	#12	#10	#10	#10	#10	#10	#8		
20	#12	#10	#10	#10	#10	#8	#8	#8	#8		
30	#10	#10	#8	#8	#8	#6	#6	#6	#6		





CIVIL ENGINEERING SURVEYING ENVIRONMENTAL SERVICES GEOTECHNICAL CONSTRUCTION SERVICES DRILLING LANDSCAPE ARCHITECTURE




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SECTION 12 T 34 N, R 06 W RESORT TOWNSHIP EMMET COUNTY, MI

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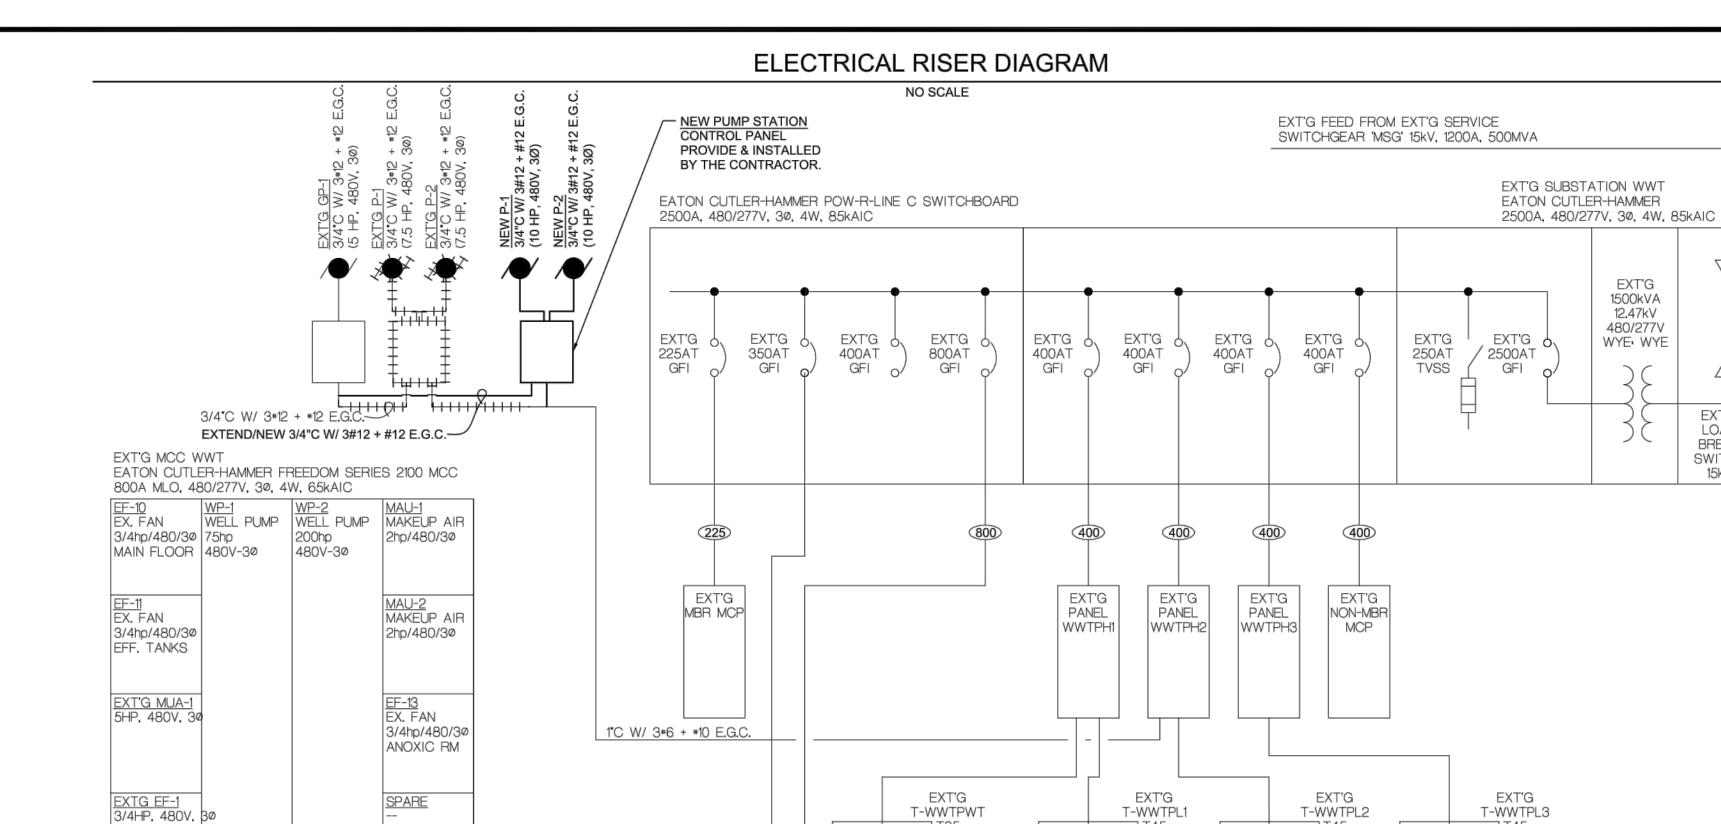
Ε>	KT'G	PANEL #WWTPH1			M.L.O. 480/277V-3Ø-4W EATON CUTLER-H RFACE PANEL	IAMMER T	YPE
CIR NO.	AMP/ POLES	DESCRIPTION	LOAD	LOAD	DESCRIPTION	AMP/ POLES	CIR NO.
1	20/1	EXT'G LTG LOWER LEVEL OPEN AREA	***	***	EXT'G LTG LEVEL 1 OPEN AREA	20/1	2
3	20/1	EXT'G LTG LOWER LEVEL OPEN AREA	***	***	EXT'G LTG LEVEL 1 OFFICE	20/1	4
5	20/1	EXT'G LTG LOWER LEVEL	***	***	EXT'G LTG LEVEL 1 EQ. RM INVERTER	20/1	6
7	20/1	SPARE	***	***	SPARE	20/1	8
9	20/1	SPARE	***	***	SPARE	20/1	10
11	20/1	SPARE		***	SPARE	20/1	12
13	20/1	SPARE		***	SPARE	20/1	14
15		SPACE			SPACE		16
17		SPACE			SPACE		18
19							20
21	15/3	EXT'G OVERHEAD DOOR	***	***	EXT'G LARGE CRANE	20/3	22
23							24
25	NEW						26
27	15/3	SCREEN MOTOR CONTROL PANEL	6,215		SPARE	20/3	28
29							30
31							32
33	70/3	SPARE		***	EXT'G SMALL CRANE	15/3	34
35							36
37	20/1	SPARE					38
39 41	70/2	EXT'G WATER TOWER	***	***	EXT'G TRANSFORMER #T-WWTPL1	70/3	40 42

PANEL ADDED LOAD: 6.2 KW - 7.8 AMPS

E>	EXT'G PANEL #WWTPH2 400 AMPS M.L.O. 480/277V-30-4W EATON CUTLER-HAMMER TYPE PRL3A SURFACE PANEL										
CIR NO.	AMP/ POLES	DESCRIPTION	LOAD	LOAD	DESCRIPTION	AMP/ POLES	CIR NO.				
1						NEW	2				
3	15/3	EXT'G CP1 (WITH P-1 (3 HP) & P-2 (3 HP))	***	+5,179	EXT'G PUMP STATION	60/3	4				
5						50/3	6				
7	20/1	SPARE					8				
9	20/1	SPARE	***		EXT'G MUFFIN MONSTER	20/3	10				
11	20/1	SPARE					12				
13							14				
15	60/3	SPARE		***	EXT'G AC-1	20/3	16				
17							18				
19							20				
21	60/3	SPARE	***		SPARE	60/3	22				
23							24				
25							26				
27	20/3	EXT'G C-1		***	EXT'G C-1 & EXT'G C-2	20/3	28				
29							30				
31	20/1	SPARE			SPARE	20/1	32				
33	20/1	SPARE		ORNE GARGE STATE	SPARE	20/1	34				
35	20/1	SPARE	Section Comp	one one ma	SPARE	20/1	36				
37	20/1	SPARE					38				
39	20/1	SPARE		***	EXT'G TRANSFORMER #T-WWTPL2	70/3	40				
41	20/1	SPARE					42				

PANEL ADDED LOAD: 5.2 KW - 6.5 AMPS

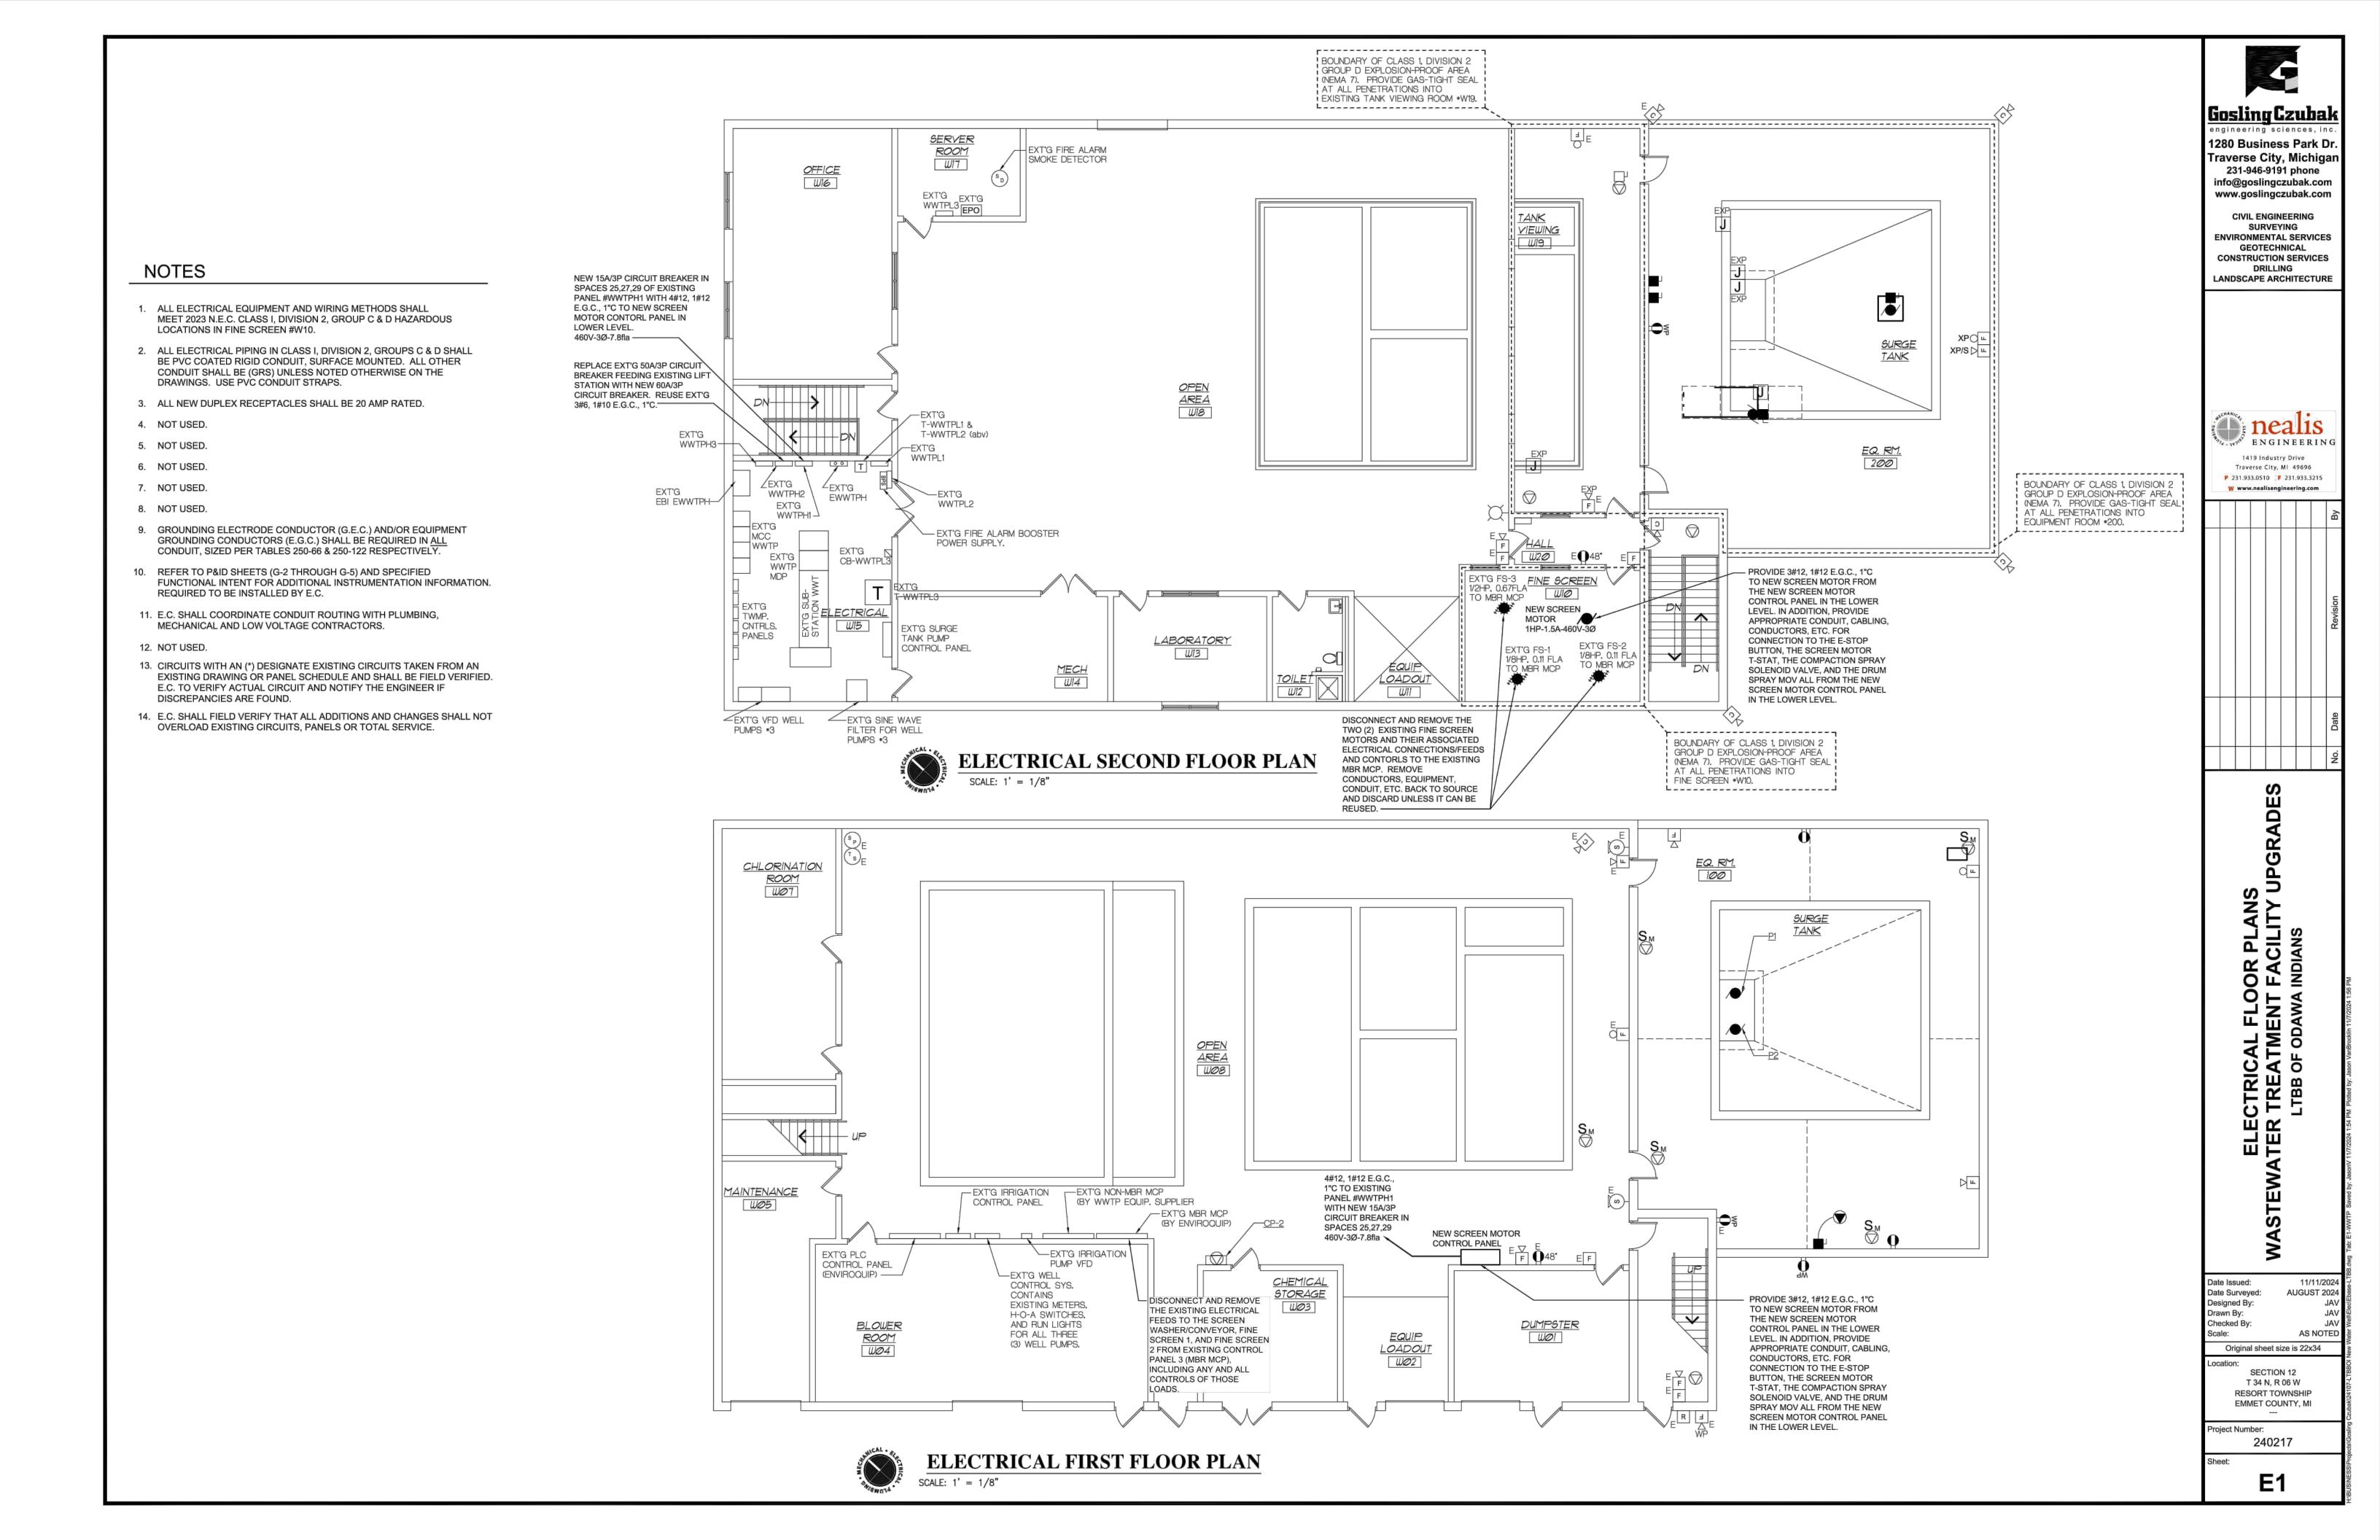CIR NO.	AMP/ POLES	DESCRIPTION	LOAD	LOAD	DESCRIPTION	AMP/ POLES	CIR
1							2
3	50/3	EXT'G CRAC-2	***	***	EXT'G CRAC-2	50/3	4
5	1						-
7		SPACE			SPACE		8
9		SPACE	CARGO CARGO CARGO		SPACE		10
11		SPACE			SPACE		12
13		SPACE			SPACE		14
15		SPACE		II	SPACE		10
17		SPACE			SPACE		18
19							20
21	45/3	EXT'G EUH-1 - FINE SCREENING	***	***	EXT'G EUH-5 - DUMPSTER	50/3	22
23							24
25							26
27	20/3	EXT'G EUH-2 - TANK VIEWING	***	***	EXT'G EUH-3 - STAIR	15/3	28
29							30
31	15/1	EXT'G EUH-4 - STAIR	***		SPARE	20/1	32
33	20/1	SPARE			SPARE	20/1	34
35	20/1	SPARE			SPARE	20/1	36
37		SPACE					38
39		SPACE		***	EXT'G TRANSFORMER *T-WWTPL3	70/3	40
41		SPACE					4:



LOAD CALCULATIONS: 7.8 AMPS EXT'G PANEL WWTPH1 6.2 KW EXT'G PANEL WWTPL1 0.0 KW 0.0 AMPS EXT'G WTR. TWR. PANEL EXT'G PANEL WWTPH2 5.2 KW 6.5 AMPS EXT'G PANEL WWTPL2 0.0 KW 0.0 AMPS EXT'G PANEL WWTPH3 0.0 KW 0.0 AMPS EXT'G PANEL WWTPL3 0.0 KW 0.0 AMPS 0.0 AMPS EXT'G MCC WWT 0.0 KW EXT'G MBR MCP 0.0 KW 0.0 AMPS TOTAL ADDED LOAD 11.4 KW 14.3 AMPS

EXT'G

WATER TOWER

PANEL

120/240V-10

100AF

T-WWTPL1

EXT'G

PANEL

WWTPL2

120/208V-3Ø

EXT'G

PANEL

WWTPL1

120/208V-3Ø

E>	KT'G	PANEL #WWTPL2			M.L.O. 120/208V-30-4W EATON CUTLER-HAN RFACE PANEL	VIMER I	YPE
CIR NO.	AMP/ POLES	DESCRIPTION	LOAD	LOAD	DESCRIPTION	AMP/ POLES	CIR NO.
1	20/1	EXT'G LIGHTING SLUDGE TANK	***	***	EXT'G RECEPTACLES - WELL PUMP	20/1	2
3	20/1	EXT'G IRRIGATION CONTROL PANEL	米米米	***	EXT'G RECEPTACLES - WELL PUMP	20/1	4
5	20/1	EXT'G WELL CONTROL SYSTEM	果果果	***	EXT'G DOOR SECURITY	20/1	6
7	20/1	EXT'G FUME HOOD	***	***	EXT'G DOOR SECURITY	20/1	8
9	20/1	EXT'G FUME HOOD EXHAUST	***	***	EXT'G DOOR SECURITY	20/1	10
11	20/1	EXT'G RECEPTS & <u>UH-1</u> -LOWER LVL & RF	***	***	EXT'G RECEPTS-W13-REF. & FIRE PANEL	20/1	12
13	20/1	EXT'G RECEPT EXTERIOR ADDITION	米米米	***	EXT'G RECEPTACLES - W13 - INCUBATOR	20/1	14
15	20/1	EXT'G CP-2 - GAS MONITORING PANEL	***	***	EXT'G RECEPTACLES - W13 - FURNACE	20/1	16
17	20/1	EXT'G GUH-1 BLOWER MAINTENANCE	***		SPARE	20/1	18
19	20/1	EXT'G GUH-1 CHEMICAL STORAGE	***		SPARE	20/1	20
21	20/1	EXT'G AC-1 VALVE PANEL	жжж		SPARE	20/1	22
23	20/1	EXT'G MOTORIZED BALL VALVES	米米米		SPARE	20/1	24
25	20/1	SPARE			SPARE	20/1	26
27	20/1	SPARE			SPARE	20/1	28
29	20/1	EXT'G RECEPTACLES - SLUDGE TANK	***		SPARE	20/1	30
31	20/1	EXT'G RECEPTACLES - SLUDGE TANK	米米米		SPARE	20/1	32
33	20/1	SPARE			SPARE	20/1	34
35	20/1	SPARE			SPARE	20/1	36
37	20/1	SPACE	***	***	EXT'G RECEPTACLE - PORTABLE PUMP	20/0	38
39	20/1	SPACE	果果果	未去来	EXIG NECEPTAGLE - PORTABLE PUMP	20/2	40
41	20/1	SPACE	***	Ī	SPARE	20/1	42

SIZE 2

SPARE

SIZE 2

SPACE

EXT'G

SINE

FILTER

EXT'G WELL PUMP #3 / 200 HP-460V-3Ø

TWO (2) PARALLEL RUNS

OF: 3*250kcmil, 1*3/0 E.G.C.,

EXT'G

WELL PUMP

#3 VFD

CIR	AMP/				I	AMP/	CIR
NO.	POLES	DESCRIPTION	LOAD	LOAD	DESCRIPTION	POLES	NO.
1	20/1	EXT'G EMERGENCY LIGHTING	宝米宝	宝米宝	EXT'G EMERGENCY LIGHTING	20/1	2
3	20/1	EXT'G EXTERIOR EGRESS LIGHTING	果業里		SPARE	20/1	4
5	20/1	SPARE			SPARE	20/1	6
7	20/1	SPARE			SPARE	20/1	8
9	20/1	SPARE			SPARE	20/1	10
11	20/1	SPARE			SPARE	20/1	12
13	20/1	SPARE			SPARE	20/1	14
15		SPACE			SPACE		16
17		SPACE			SPACE		18
19		SPACE			SPACE		20
21		SPACE			SPACE		22
23		SPACE			SPACE		24
25		SPACE		l	SPACE		26
27		SPACE		Ī	SPACE		28
29		SPACE			SPACE		30



DRILLING

EXT'G LOAD BREAK SWITCH

15kV

K-13

EXT'G

150/3

EPO


CB WWTPL3

EXT'G PANEL

|WWTPL3|

120/208V-3Ø

LANDSCAPE ARCHITECTURE

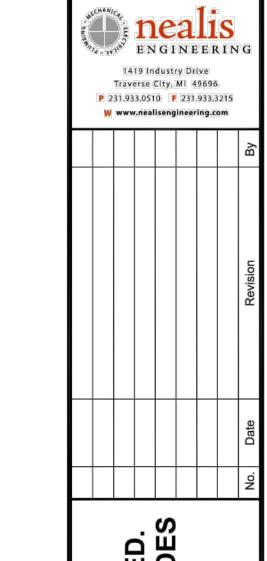

SCHED. ELECTRICAL RISER DIAGRAM & PANEL WASTEWATER TREATMENT FACILITY UI LTBB OF ODAWA INDIANS


Date Issued: 11/11/2024 Date Surveyed: AUGUST 2024 Designed By: Drawn By: Checked By:

AS NOTED Original sheet size is 22x34 Location: SECTION 12

T 34 N, R 06 W RESORT TOWNSHIP EMMET COUNTY, MI


Project Number: 240217

E2

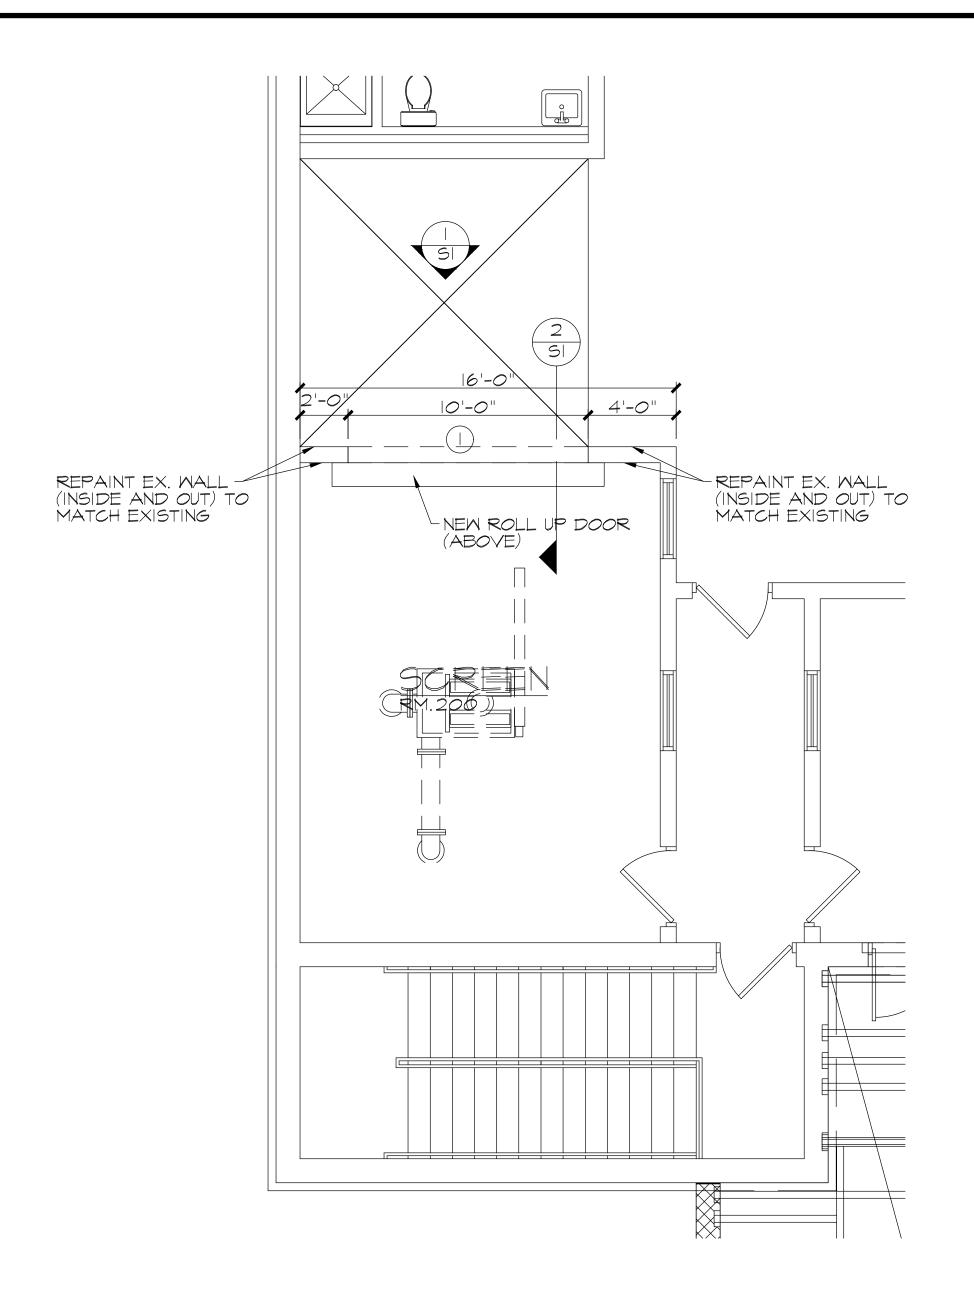



	DOOR SCHEDULE										
NO.	DOOR LOCATION	SIZE	TYPE	DOOR MATERIAL	MATERIAL	FRAN HEAD	JAMB	SILL	LABEL	HDWR	NOTES
	SCREEN (RM. 200)	10'-0"× 10'-0"	A	INS. SS MET.					I½ HR		

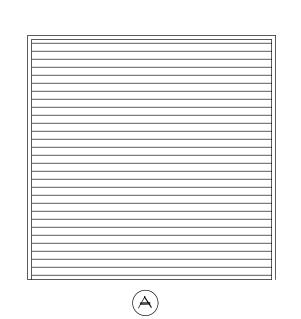

HARDMARE SCHEDULE:

SET 1: (1) OVERHEAD DOOR HARDWARE MANUAL CHAIN DRIVEN OPERATION

DOOR TO BE OVERHEAD DOOR CO.

| HR. FIRE-RATED INSULATED


ROLLING SERVICE DOOR MODEL

635, STAINLESS STEEL OR

APPROVED EQUAL. ALL DOOR

HARDWARE AND COMPONENTS TO

BE STAINLESS STEEL.

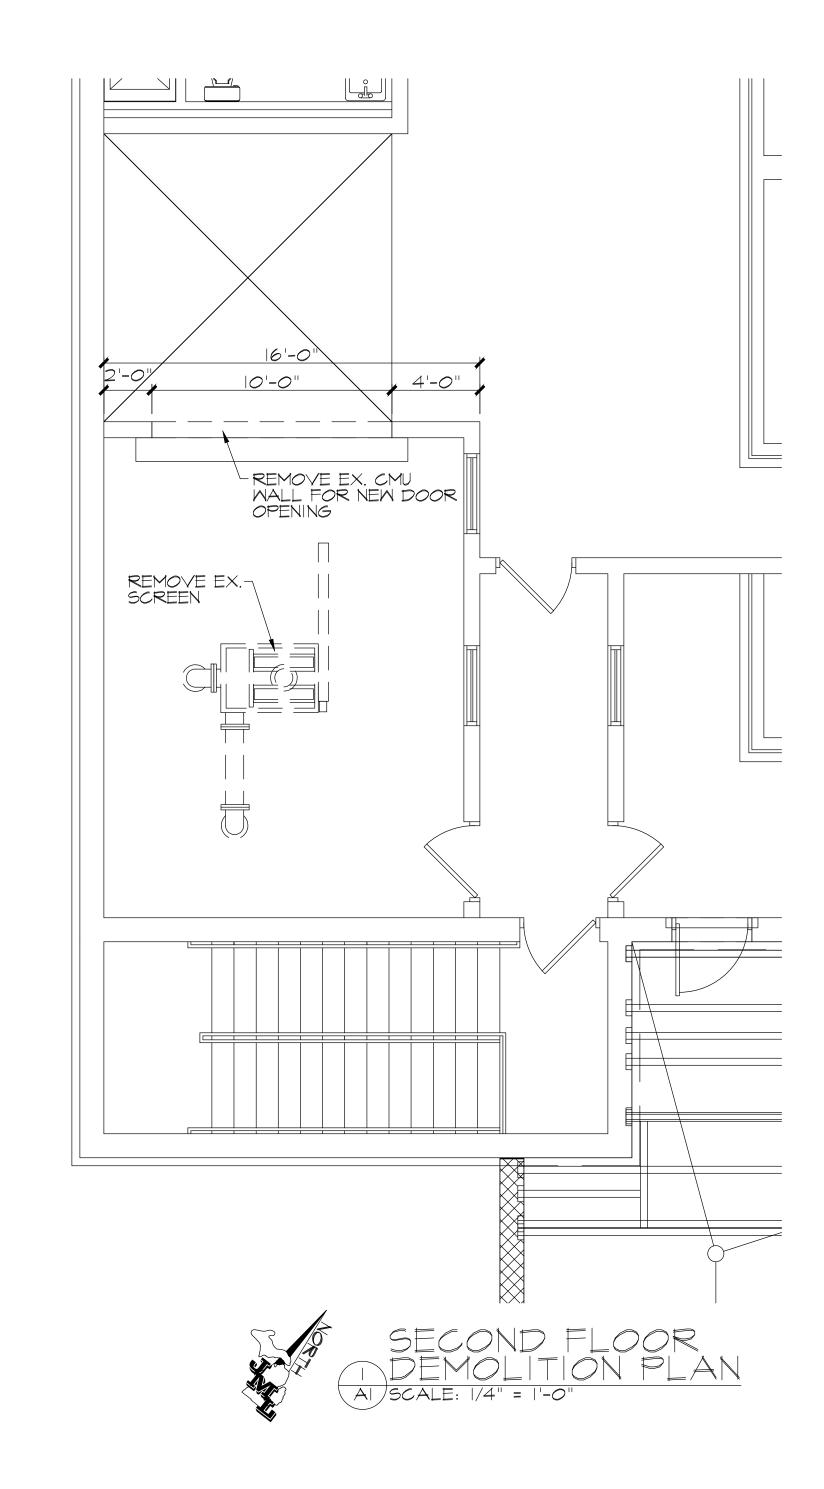

Gosling Gzuhak engineering sciences, inc.

1280 Business Park Dr. Traverse City, Michigan 231-946-9191 phone info@goslingczubak.com www.goslingczubak.com

CIVIL ENGINEERING SURVEYING ENVIRONMENTAL SERVICES GEOTECHNICAL CONSTRUCTION SERVICES DRILLING

LANDSCAPE ARCHITECTURE

ADES FLOOR PLAN

R TREATMENT FACILITY I

LTBB OF ODAWA INDIANS **WASTEWATER**

AUGUST 2024 GLW Date Surveyed: Designed By: Drawn By: Checked By:


AS NOTED Original sheet size is 22x34


GLW


SECTION 12 T 34 N, R 06 W RESORT TOWNSHIP EMMET COUNTY, MI

Project Number:

240217

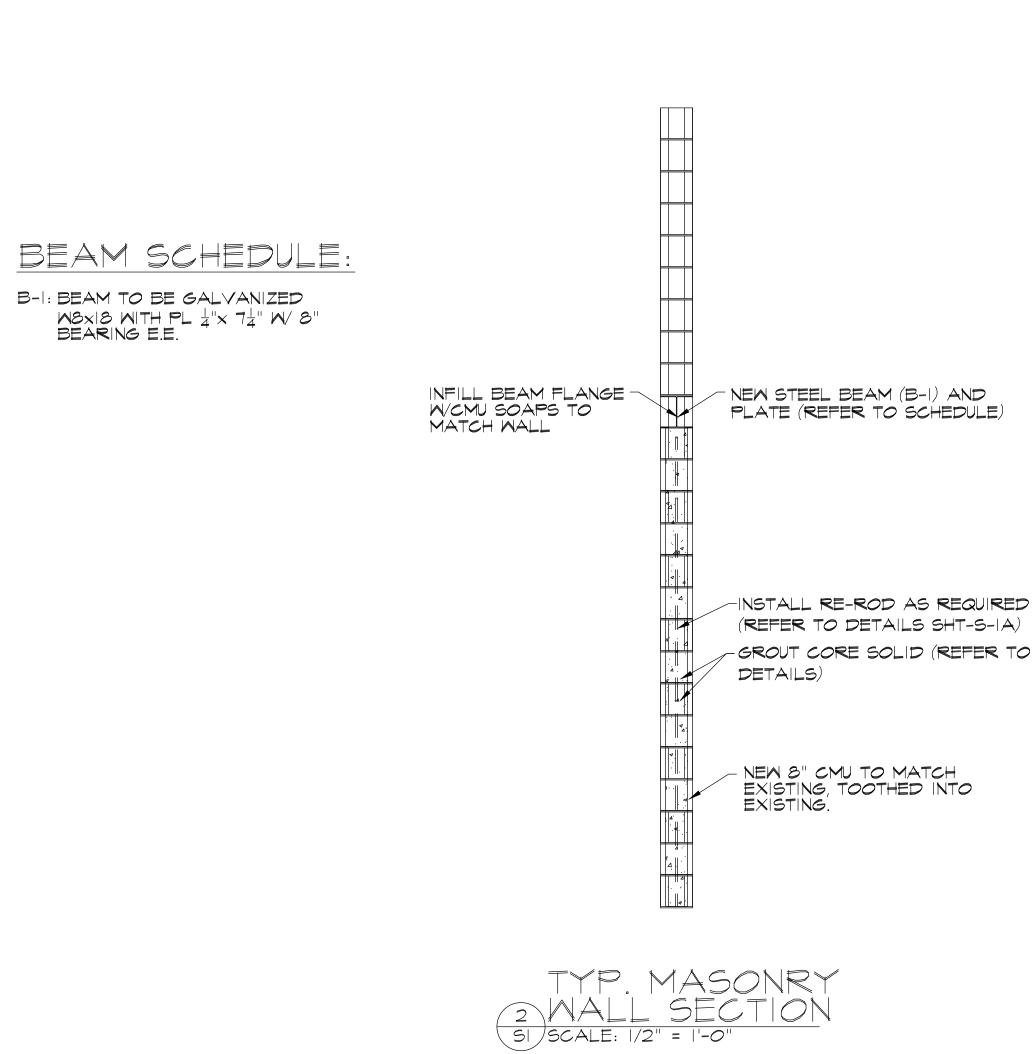

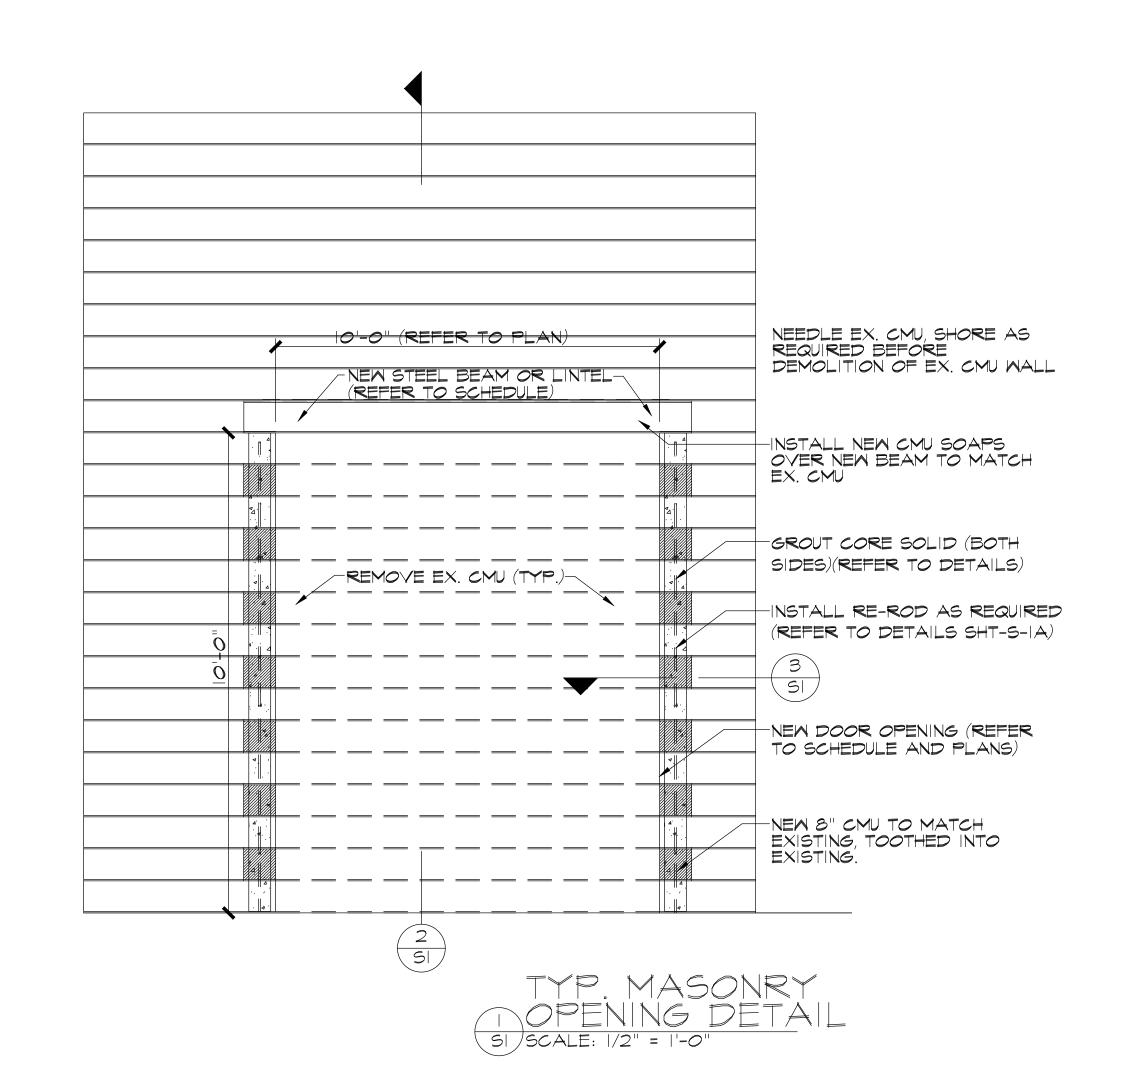

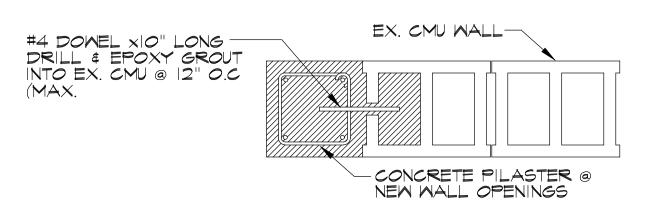

TYP. MASONRY

3 OPENING SECTION

SI SCALE: NOT TO SCALE

Gosling Czuba

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CIVIL ENGINEERING SURVEYING **ENVIRONMENTAL SERVICES** GEOTECHNICAL CONSTRUCTION SERVICES

LANDSCAPE ARCHITECTURE



			GLW	By
			ADDENDUM #1	Revision
			11-12-24	Date
			1	No.

STRUCTURAL DETAILS
WASTEWATER TREATMENT FACILITY
LTBB OF ODAWA INDIANS

Date Surveyed: Designed By: Drawn By: Checked By:

Original sheet size is 22x34

SECTION 12 T 34 N, R 06 W RESORT TOWNSHIP EMMET COUNTY, MI

240217

S1

AUGUST 2024 GLW

GLW AS NOTED